


Umma More Renewable Energy Development, Co. Westmeath Planning Permission Application Drawings








Schedule of Drawings


| Drawing No. | Drawing Title | Scale | Page Size |
|--------------|--|----------------|-----------|
| 201050 - 01 | Location Context Map | 1: 50,000 | A3 |
| 201050 - 02 | Site Location Map | 1: 20,000 | A3 |
| 201050 - 02A | Site Notice Location Map A | 1:2,500 | A3 |
| 201050 - 02B | Site Notice Location Map B | 1:2,500 | A3 |
| 201050 - 02C | Site Notice Location Map C | 1:2,500 | A3 |
| 201050 - 02D | Site Notice Location Map D | 1:2,500 | A3 |
| 201050 - 02E | Site Notice Location Map E | 1:2,500 | A3 |
| 201050 - 02F | Site Notice Location Map F | 1:2,500 | A3 |
| 201050 - 02G | Site Notice Location Map G | 1:2,500 | A3 |
| 201050 - 02H | Site Notice Location Map H | 1:2,500 | A3 |
| 201050 - 03 | Site Layout Key Plan (1:5,000) | 1: 10,000 | A1 |
| 201050 - 04 | Site Layout 1:5,000 Sheet 1 of 2 | 1: 5,000 | A1 |
| 201050 - 05 | Site Layout 1:5,000 Sheet 2 of 2 | 1: 5,000 | A1 |
| 201050 - 06 | Site Layout Key Plan (1:2,500) | 1: 10,000 | A1 |
| 201050 - 07 | Site Layout 1:2,500 Sheet 1 of 6 | 1:2,500 | A1 |
| 201050 - 08 | Site Layout 1:2,500 Sheet 2 of 6 | 1:2,500 | A1 |
| 201050 - 09 | Site Layout 1:2,500 Sheet 3 of 6 | 1:2,500 | A1 |
| 201050 - 10 | Site Layout 1:2,500 Sheet 4 of 6 | 1:2,500 | A1 |
| 201050 - 11 | Site Layout 1:2,500 Sheet 5 of 6 | 1:2,500 | A1 |
| 201050 - 12 | Site Layout 1:2,500 Sheet 6 of 6 | 1:2,500 | A1 |
| 201050 - 13 | Turbine 1 Layout | 1:500 | A3 |
| 201050 - 14 | Turbine 2 Layout | 1:500 | A3 |
| 201050 - 15 | Turbine 3 Layout | 1:500 | A3 |
| 201050 - 16 | Turbine 4 Layout | 1:500 | A3 |
| 201050 - 17 | Turbine 5 Layout | 1:500 | A3 |
| 201050 - 18 | Turbine 6 Layout | 1:500 | A3 |
| 201050 - 19 | Turbine 7 Layout | 1:500 | A3 |
| 201050 - 20 | Turbine 8 Layout | 1:500 | A3 |
| 201050 - 21 | Turbine 9 Layout | 1:500 | A3 |
| 201050 - 22 | Temporary Construction Compound | 1:500 | A3 |
| 201050 - 23 | Met Mast | As Shown | A3 |
| 201050 - 24 | Wind Turbine Elevations & Plan | 1:500 | A1 |
| 201050 - 25 | Existing Road for Upgrade Excavated Road Section | 1:50 | A3 |
| 201050 - 26 | Proposed New Excavated Road Section | 1:50 | A3 |
| 201050 - 27 | Excavated road section in Site-Specific Flood Modelled Zones | | A3 |
| 201050 - 27 | <u> </u> | 1:50 1:20 | A3 |
| | Site Signage Field Gate Detail | | |
| 201050 - 29 | | 1:20 | A3 |
| 201050 - 30 | Site Office & Staff Facilities Detail | 1:100 | A3 |
| 201050 - 31 | Clear Span Bridge Crossing | As Shown | A3 |
| 201050 – 32 | 33kV Cable Trench Sections | 1:10 | A3 |
| Drawing No. | HES Drawings | Scale | Page Size |
| D101 | Proposed Drainage Layout | 1: 2,000 | A1 |
| D102 | Proposed Drainage Layout | 1: 2,000 | A1 |
| D103 | Proposed Drainage Layout | 1: 2,000 | A1 |
| D104 | Proposed Drainage Layout | 1: 2,000 | A1 |
| D105 | Proposed Drainage Layout | 1: 2,000 | A1 |
| D501 | Drainage Details 1 | As Shown | A1 |
| D502 | Drainage Details 2 | As Shown | A1 |
| D503 | Drainage Details 3 | As Shown | A1 |
| 2000 | Ziming Domio | 1.10 0110 1/11 | |

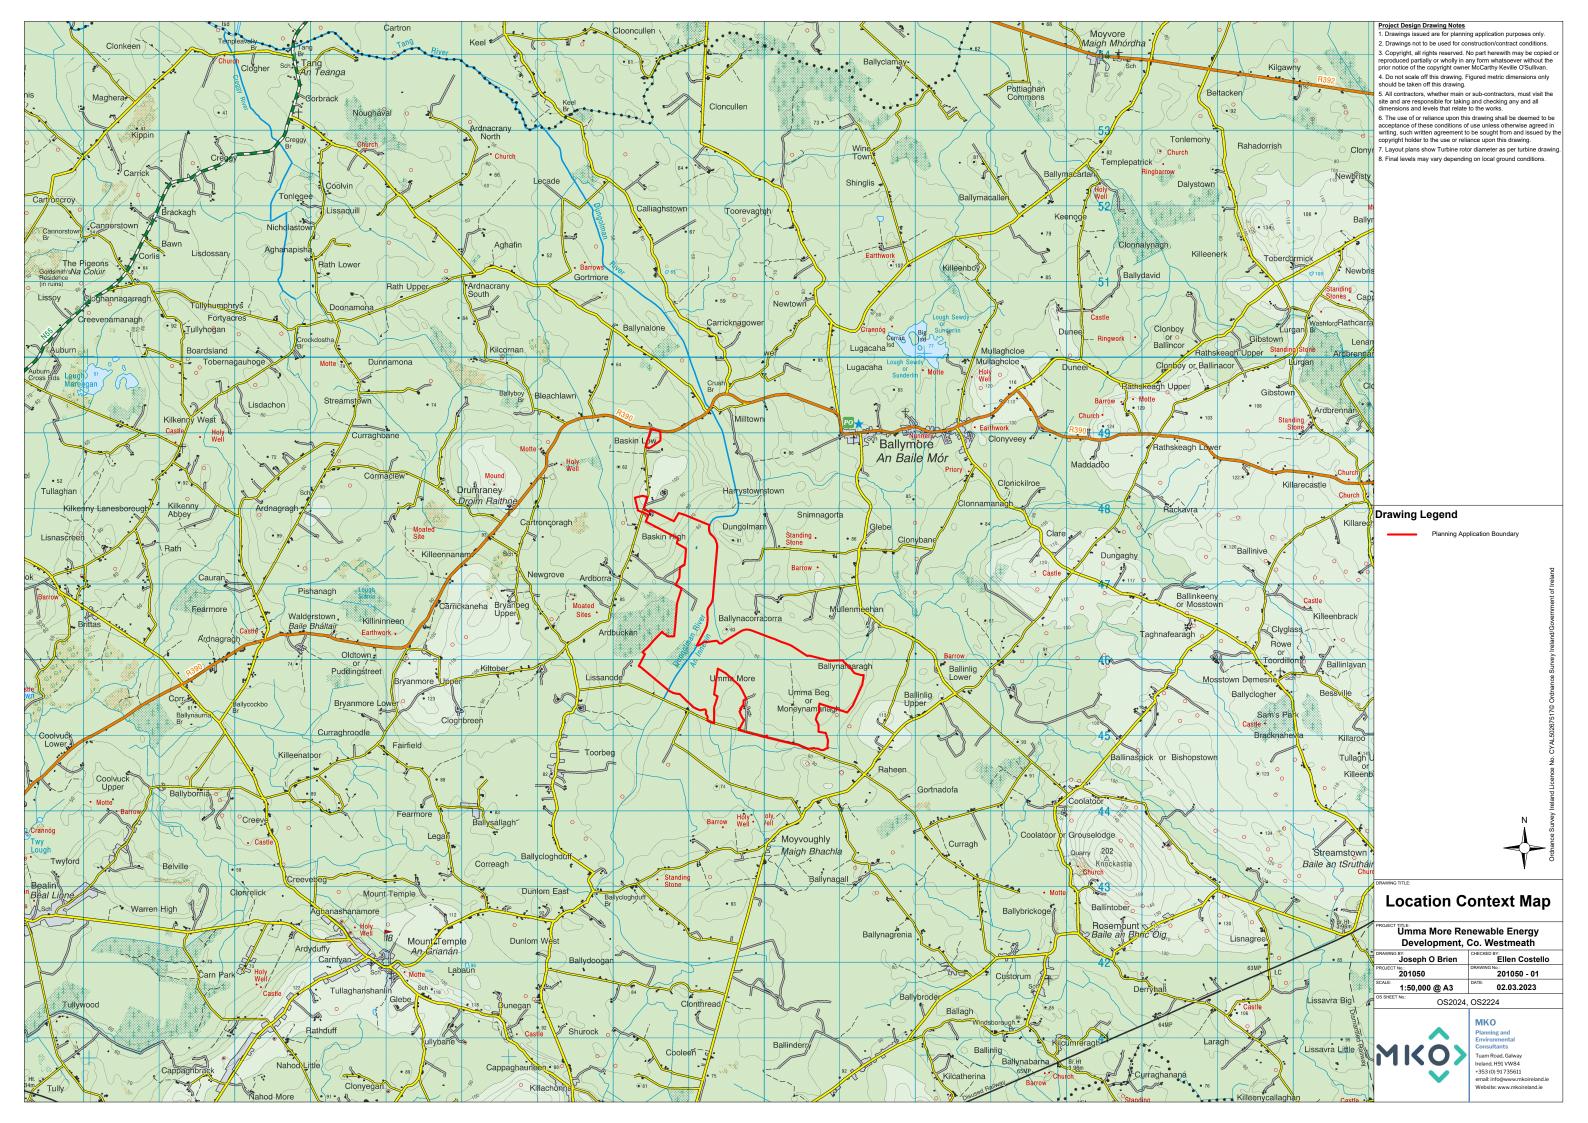


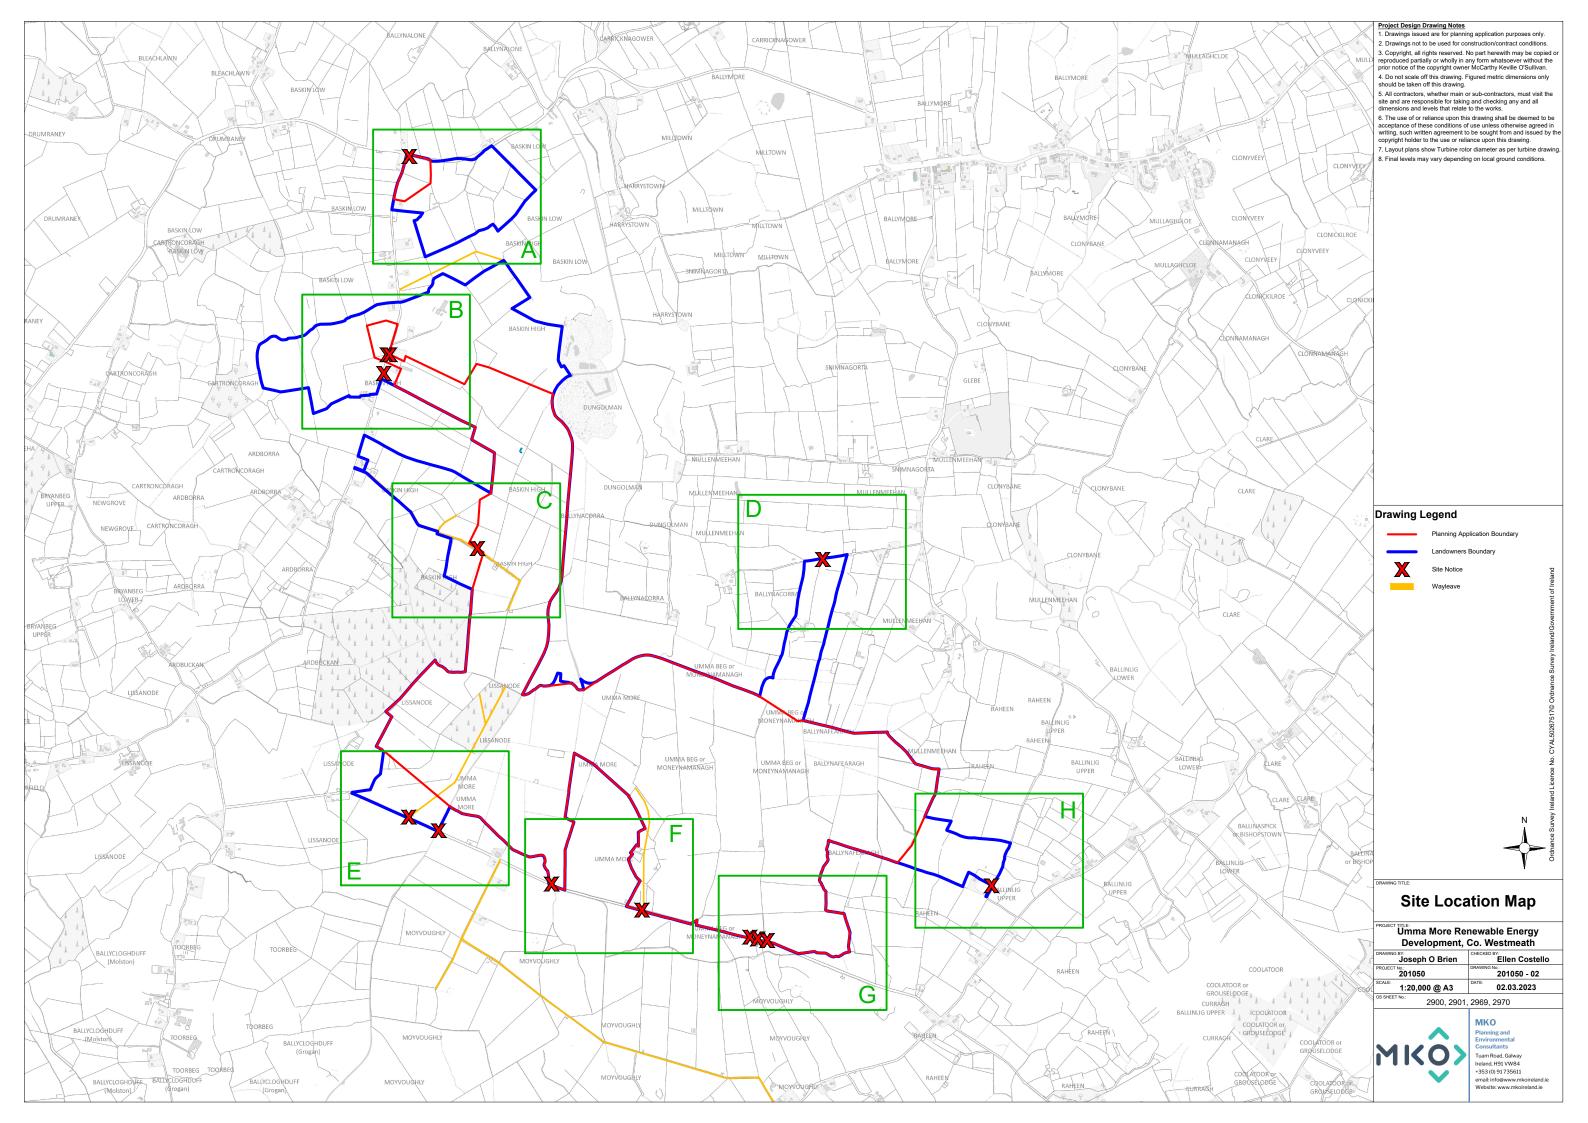


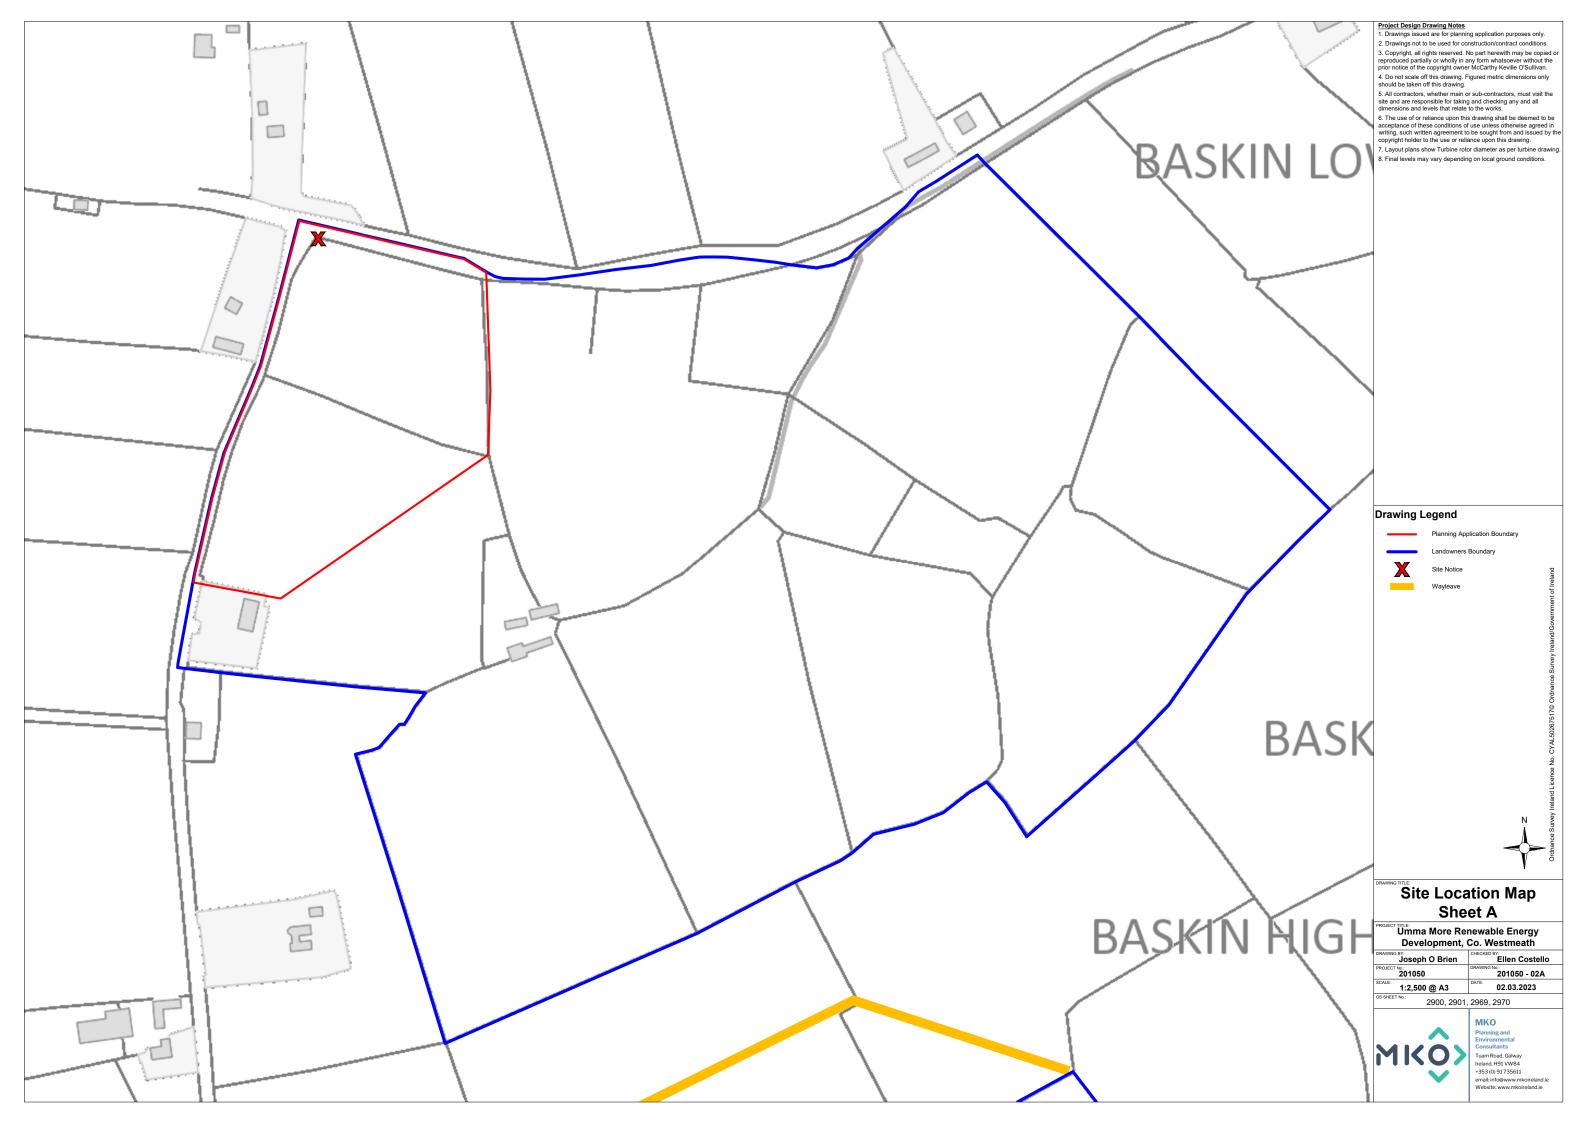


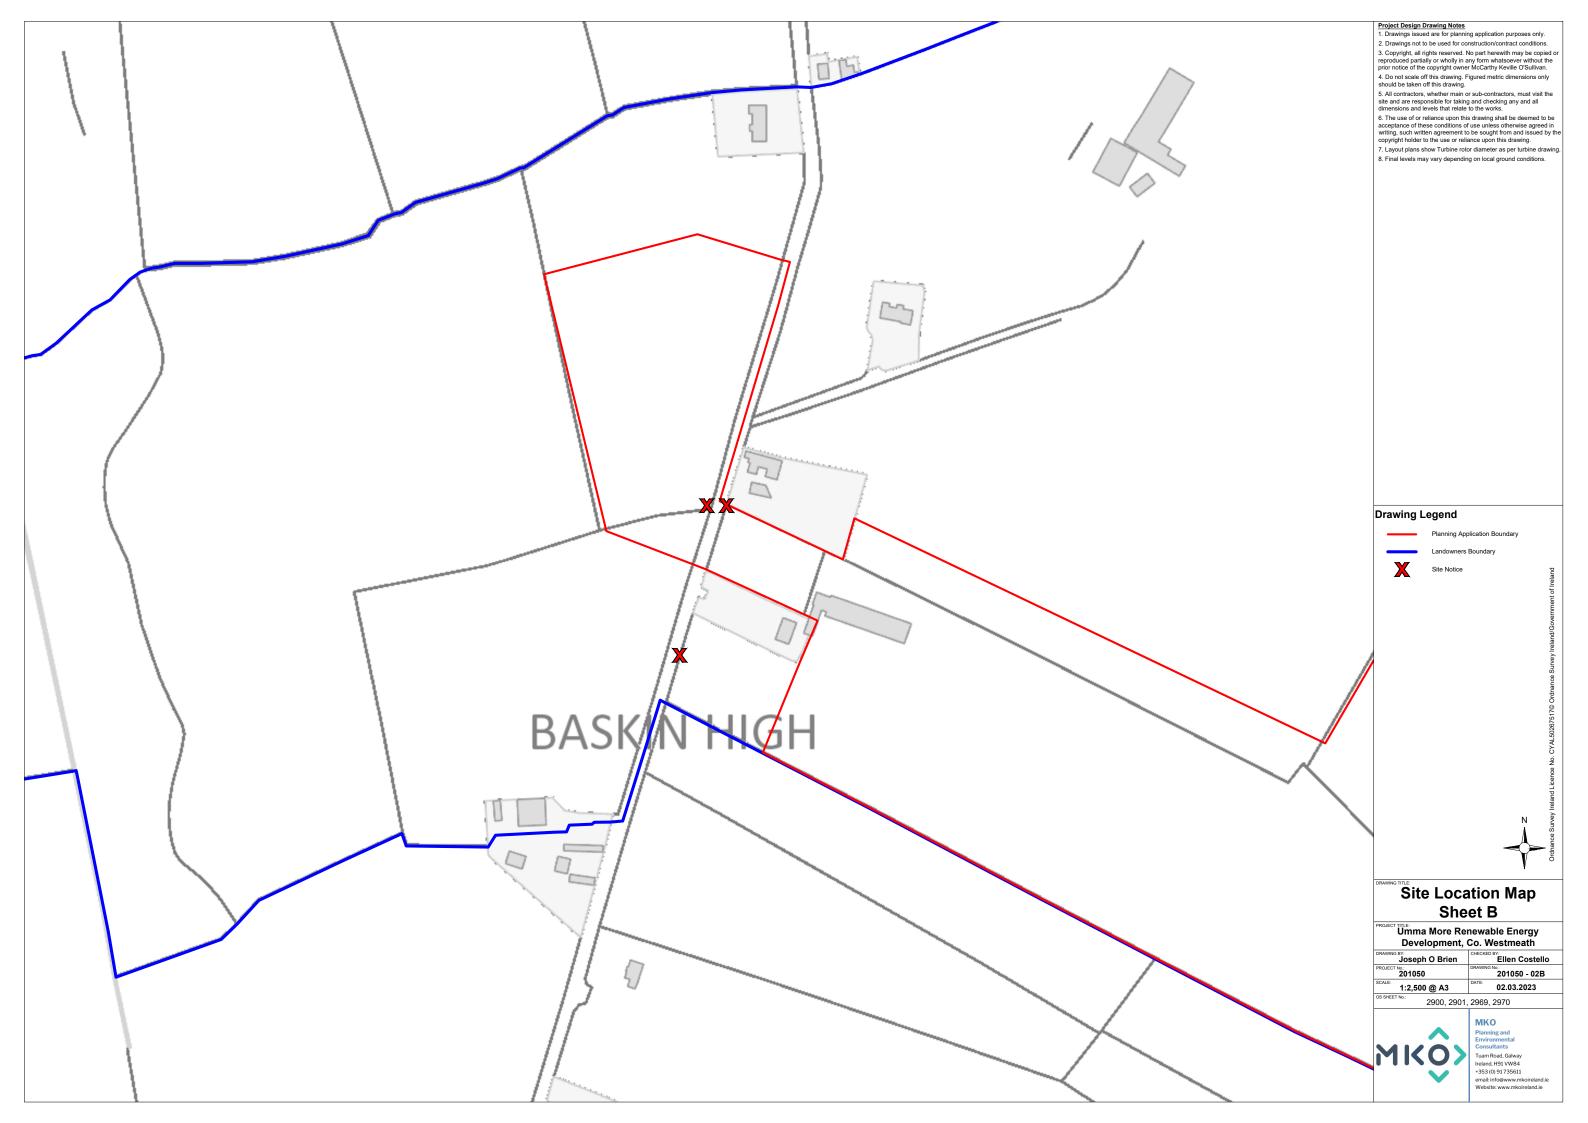


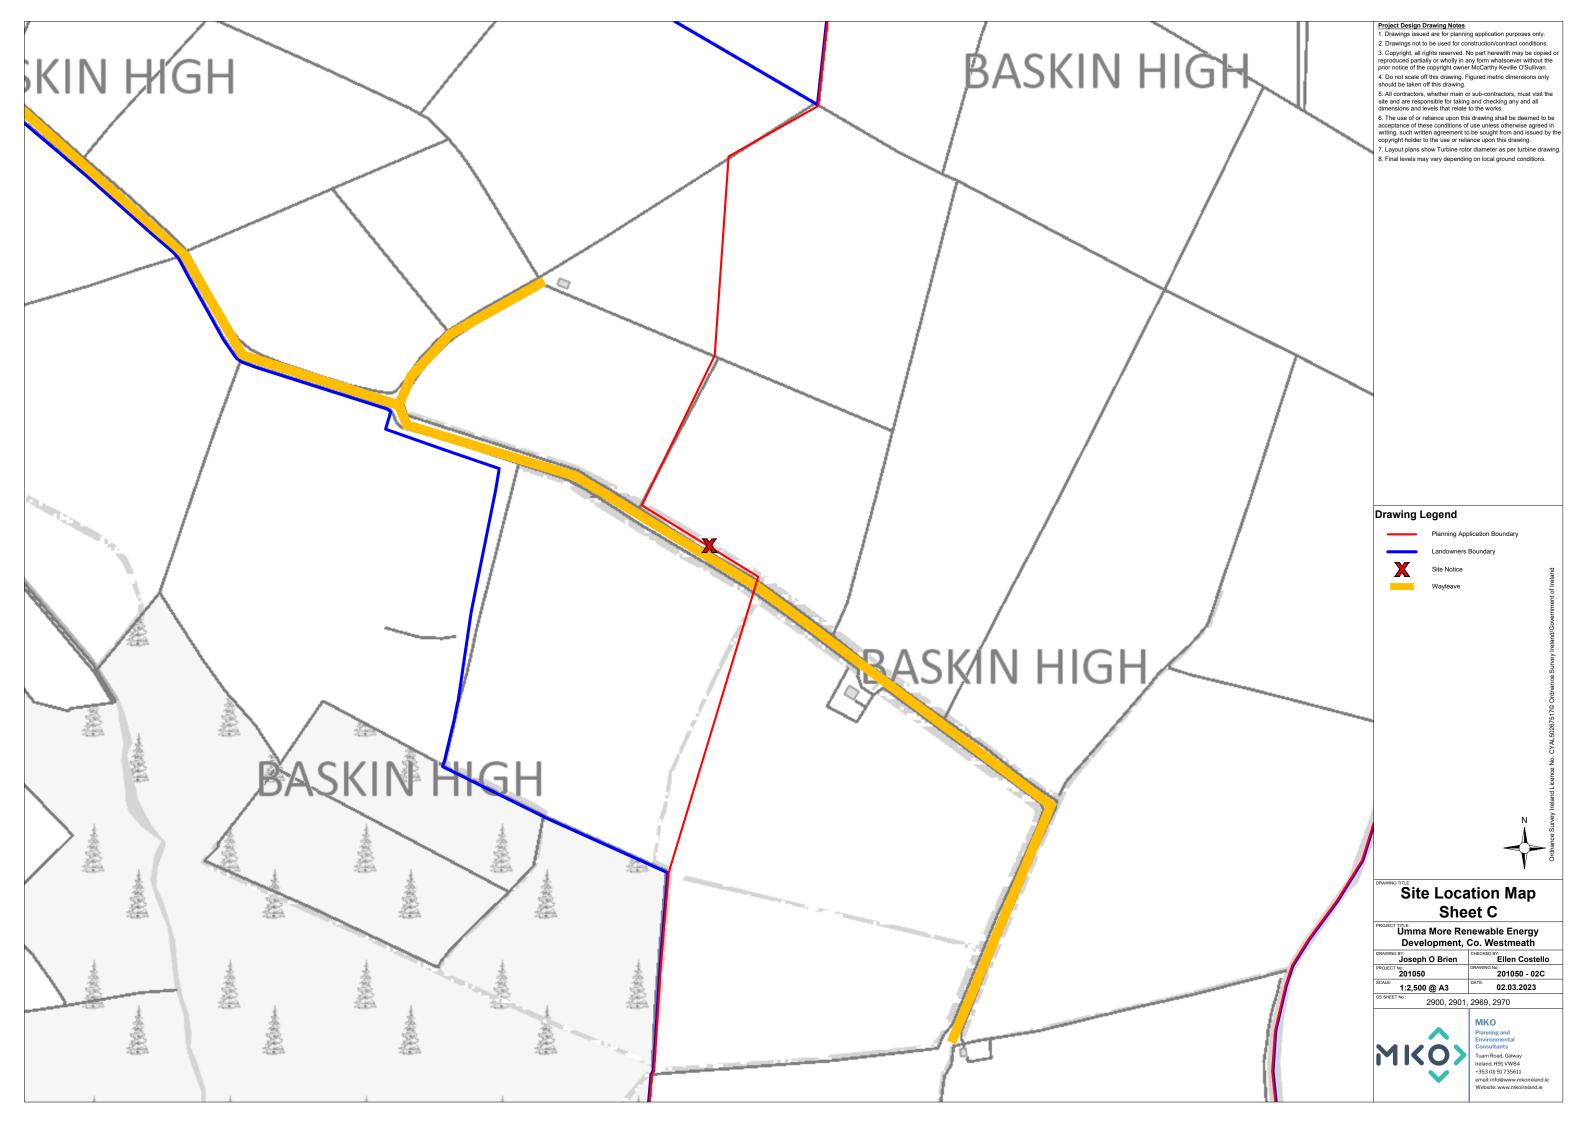


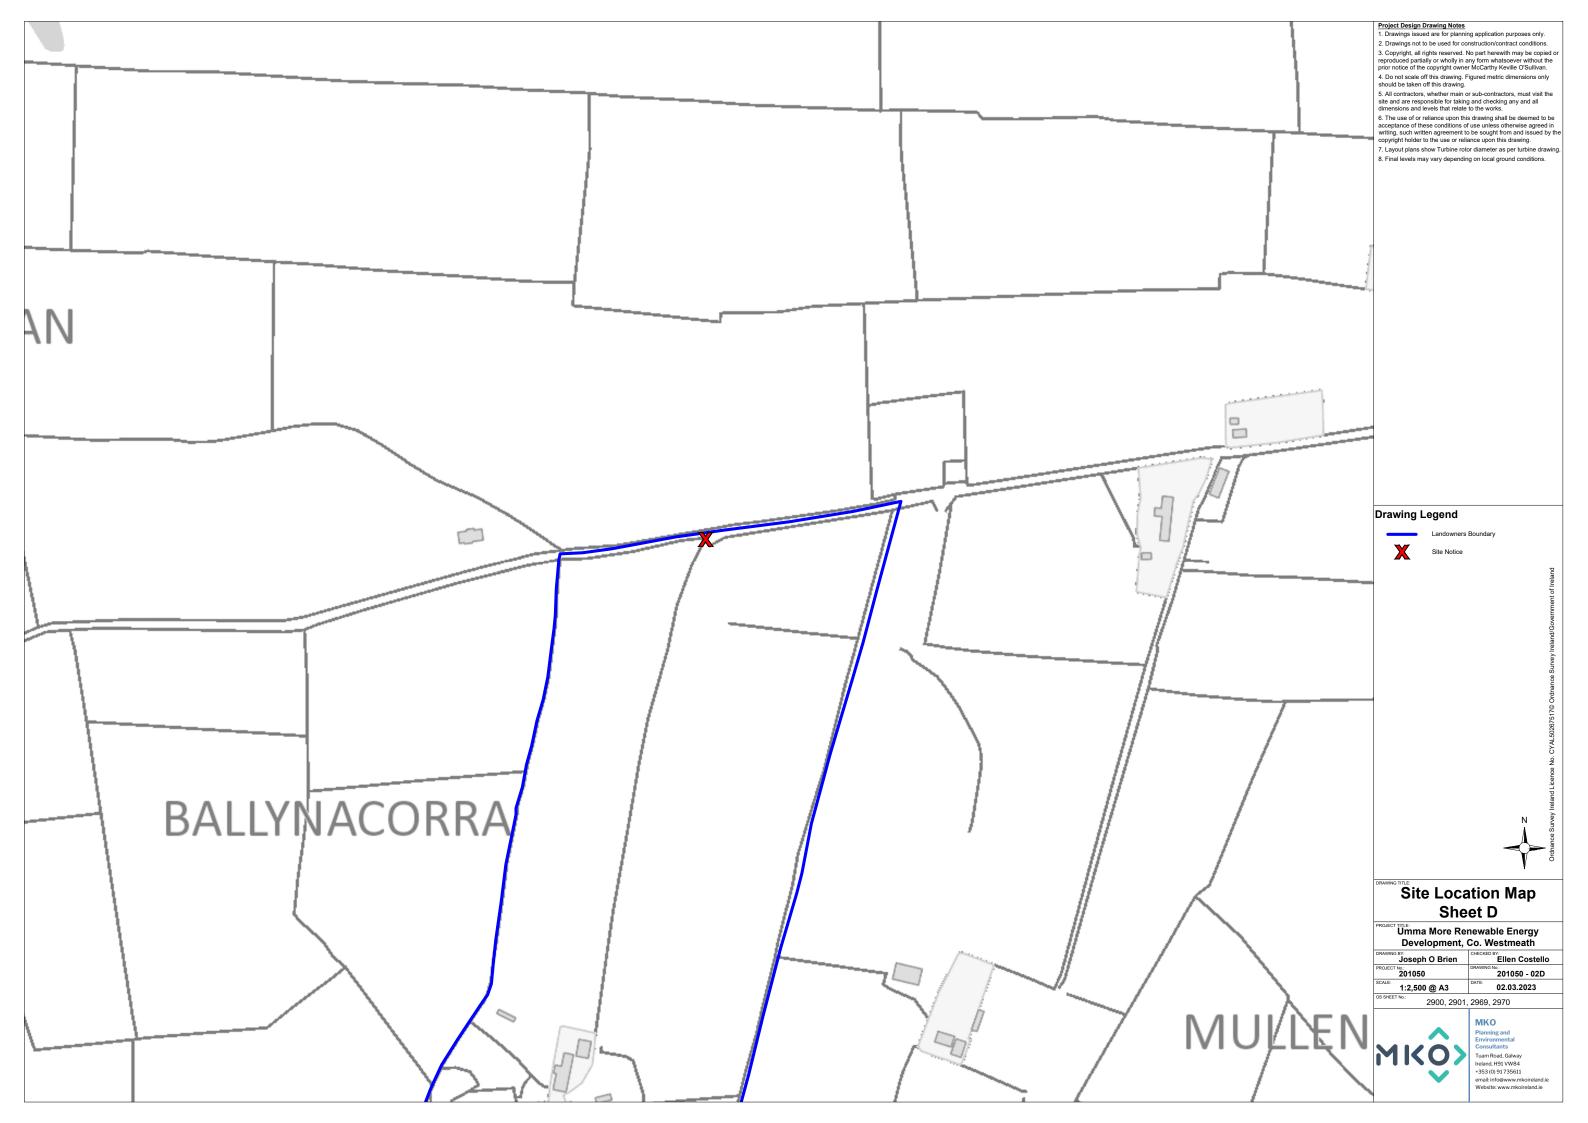


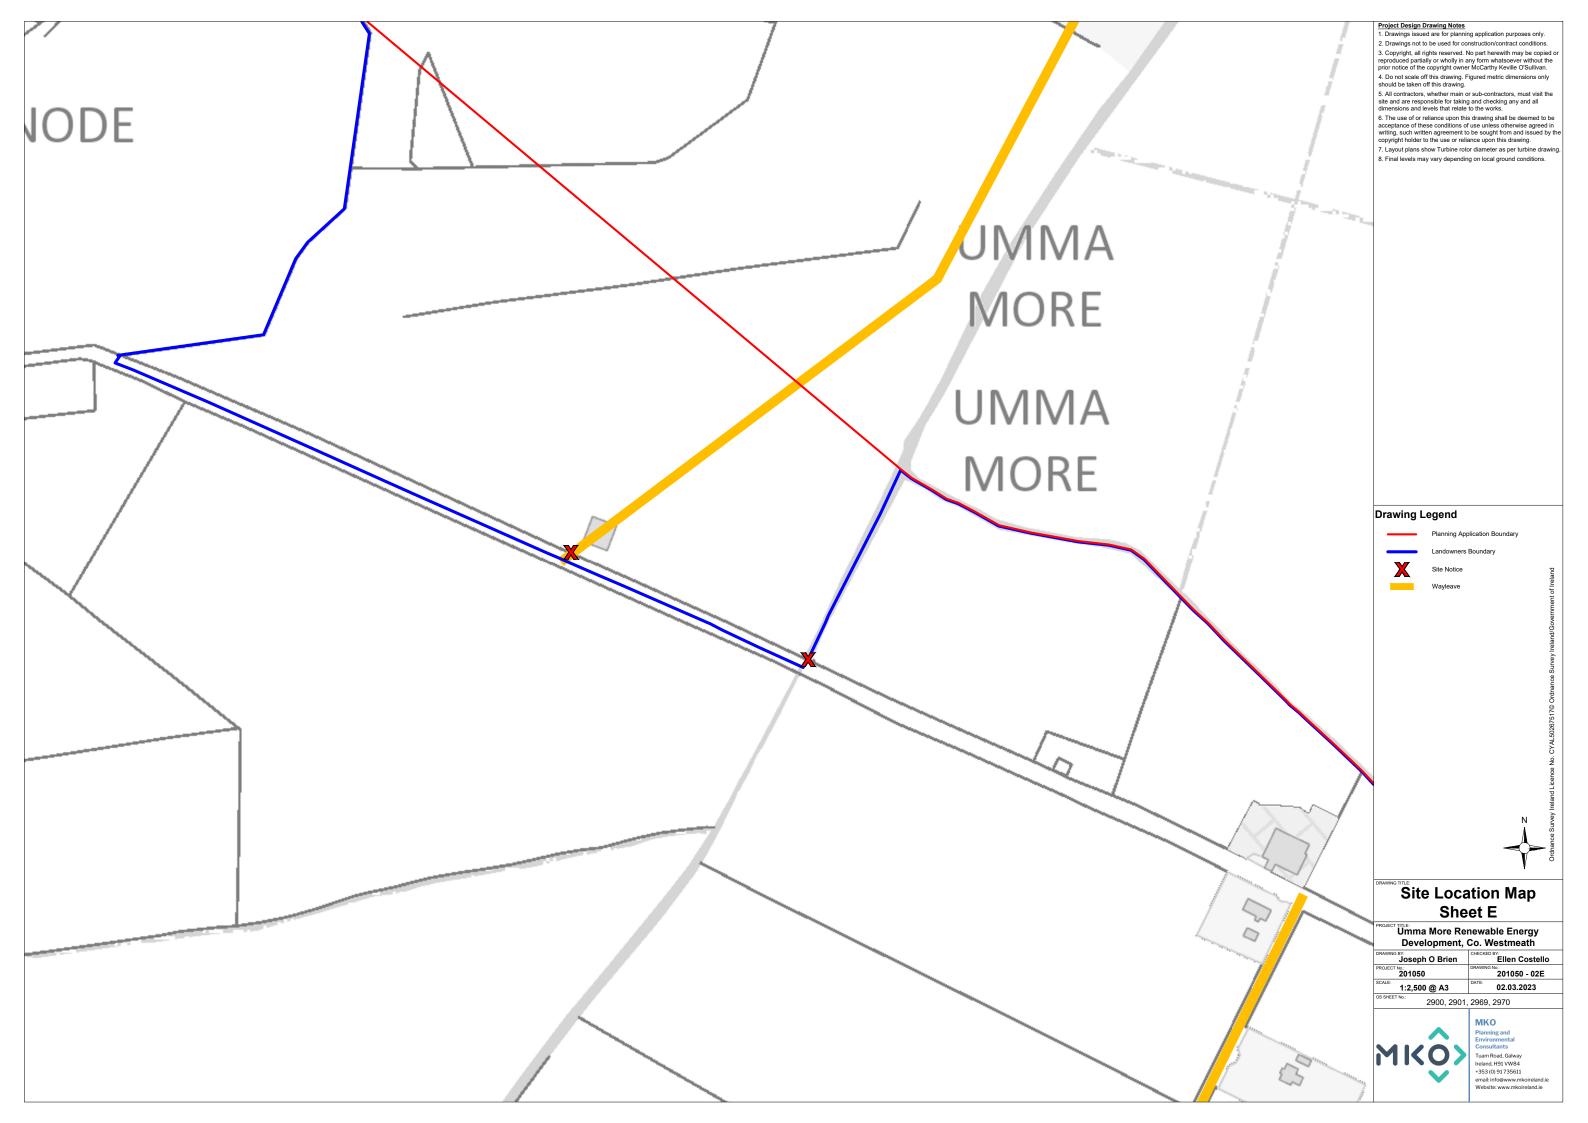

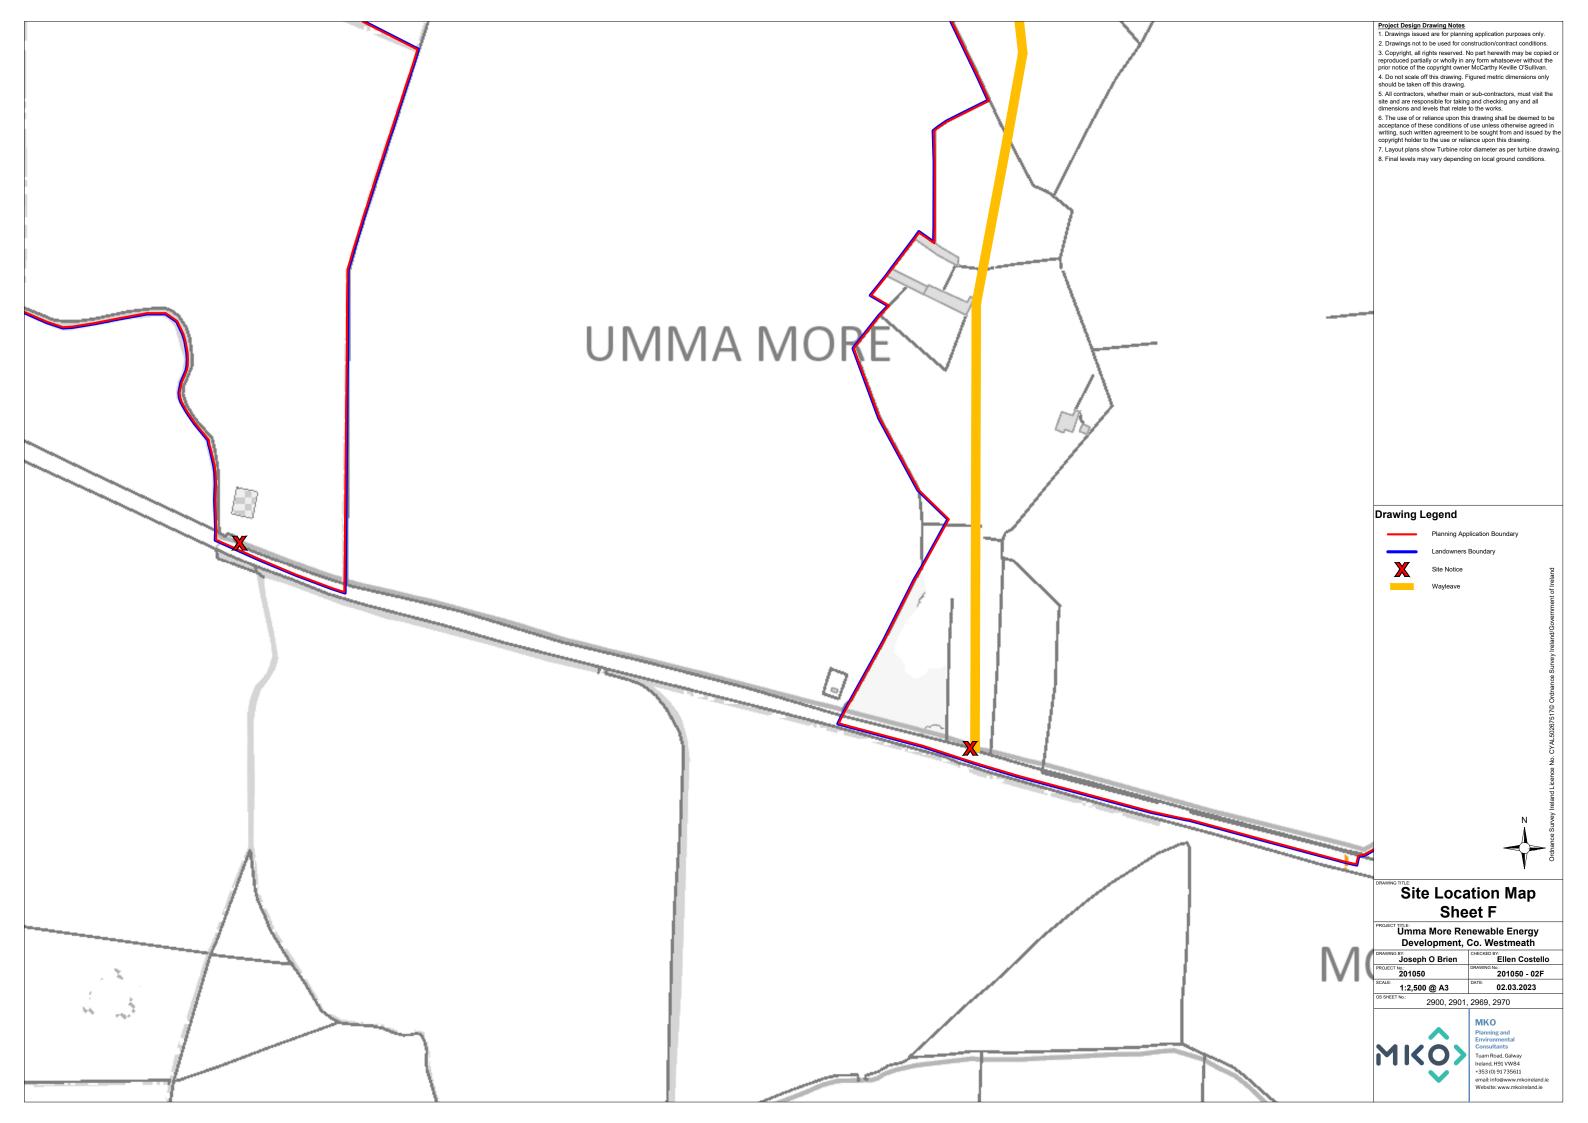


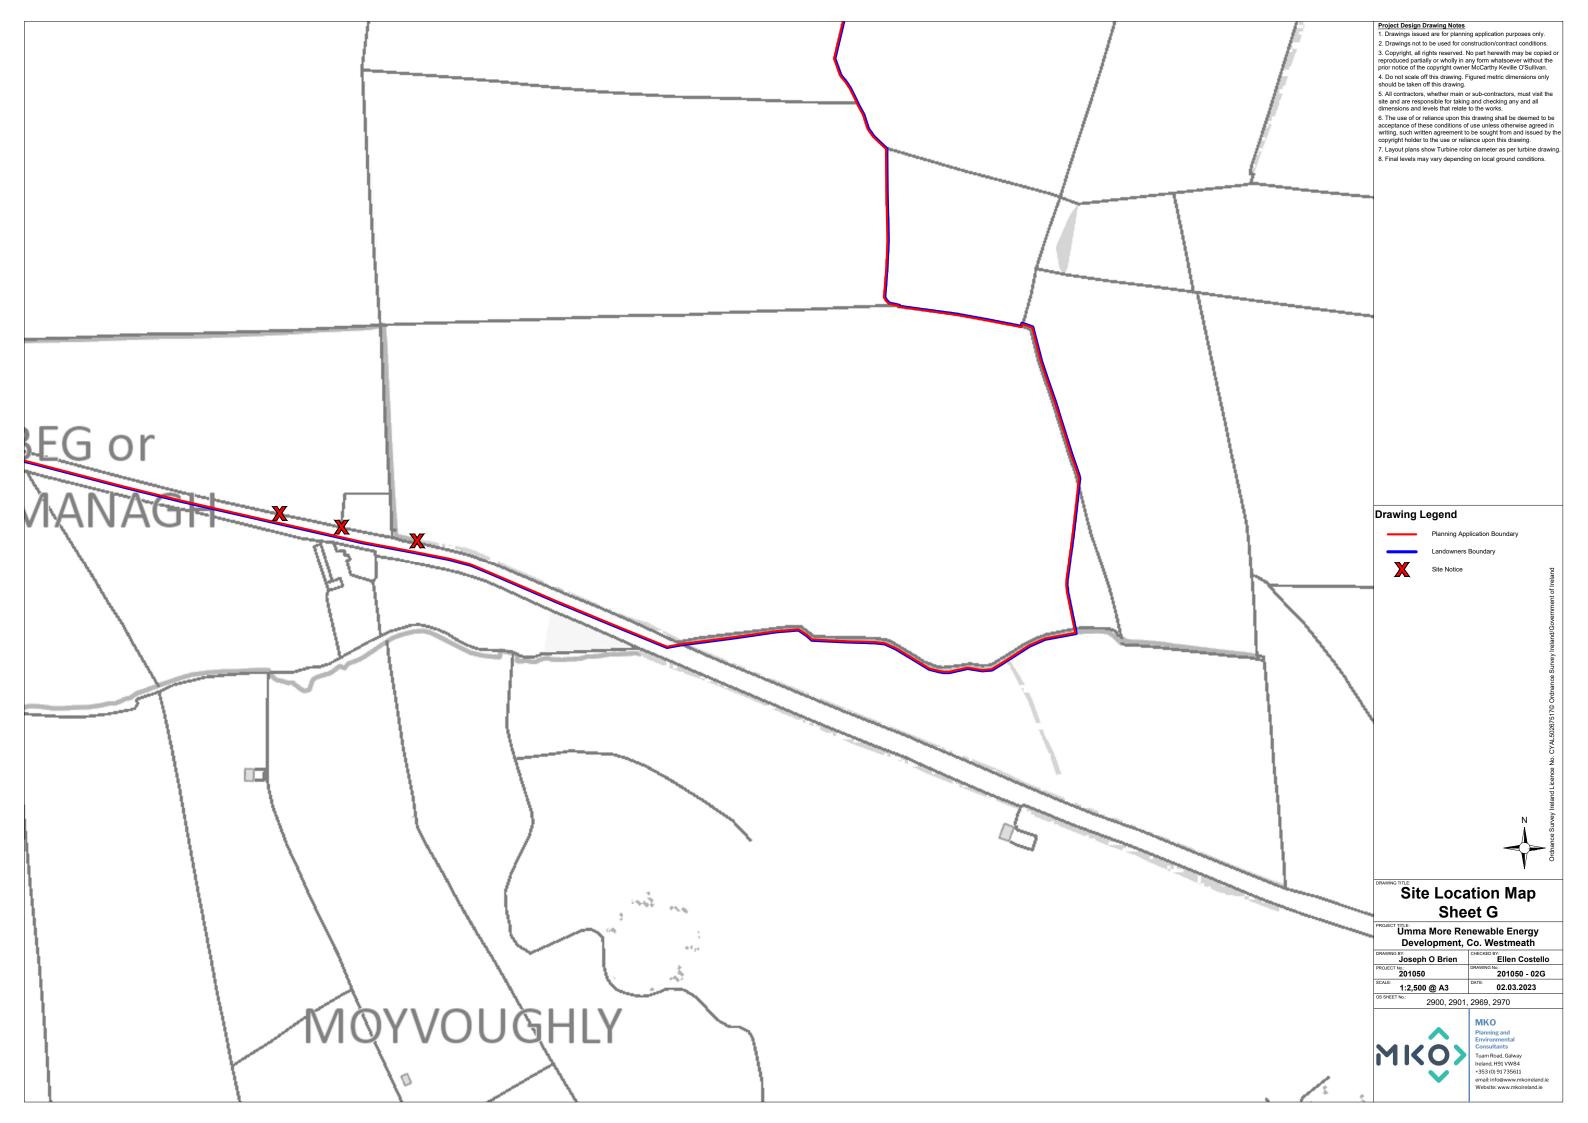


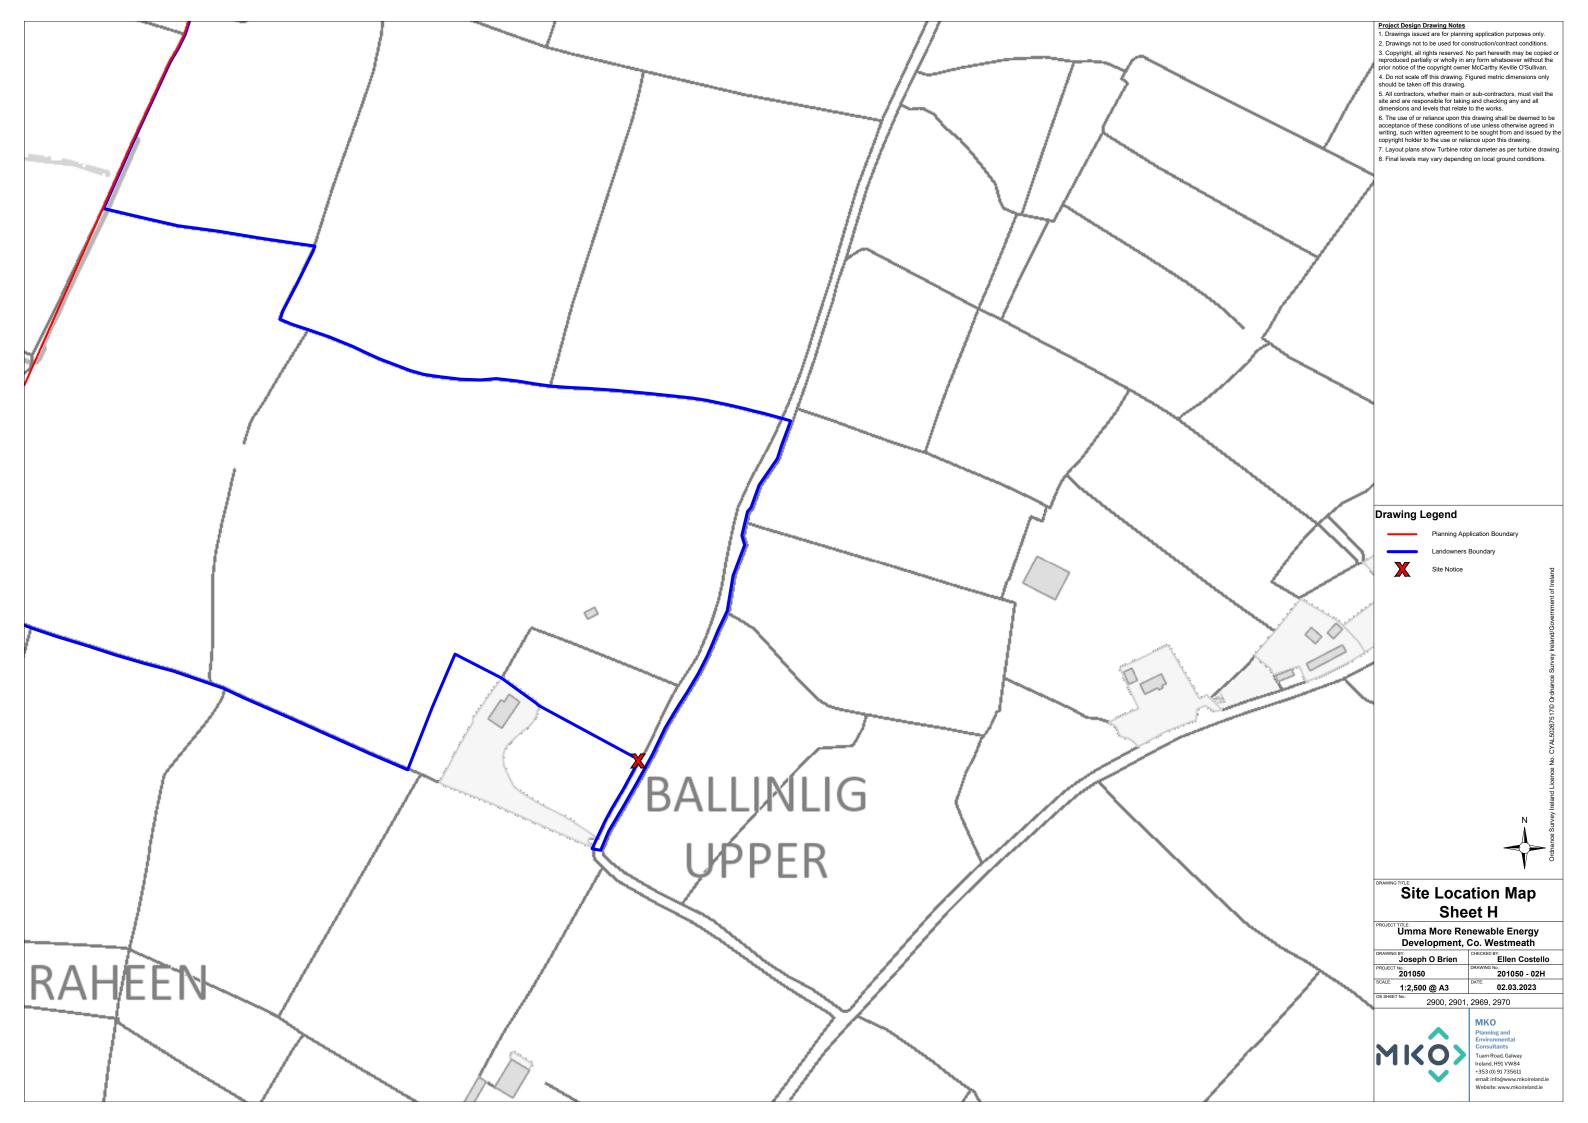

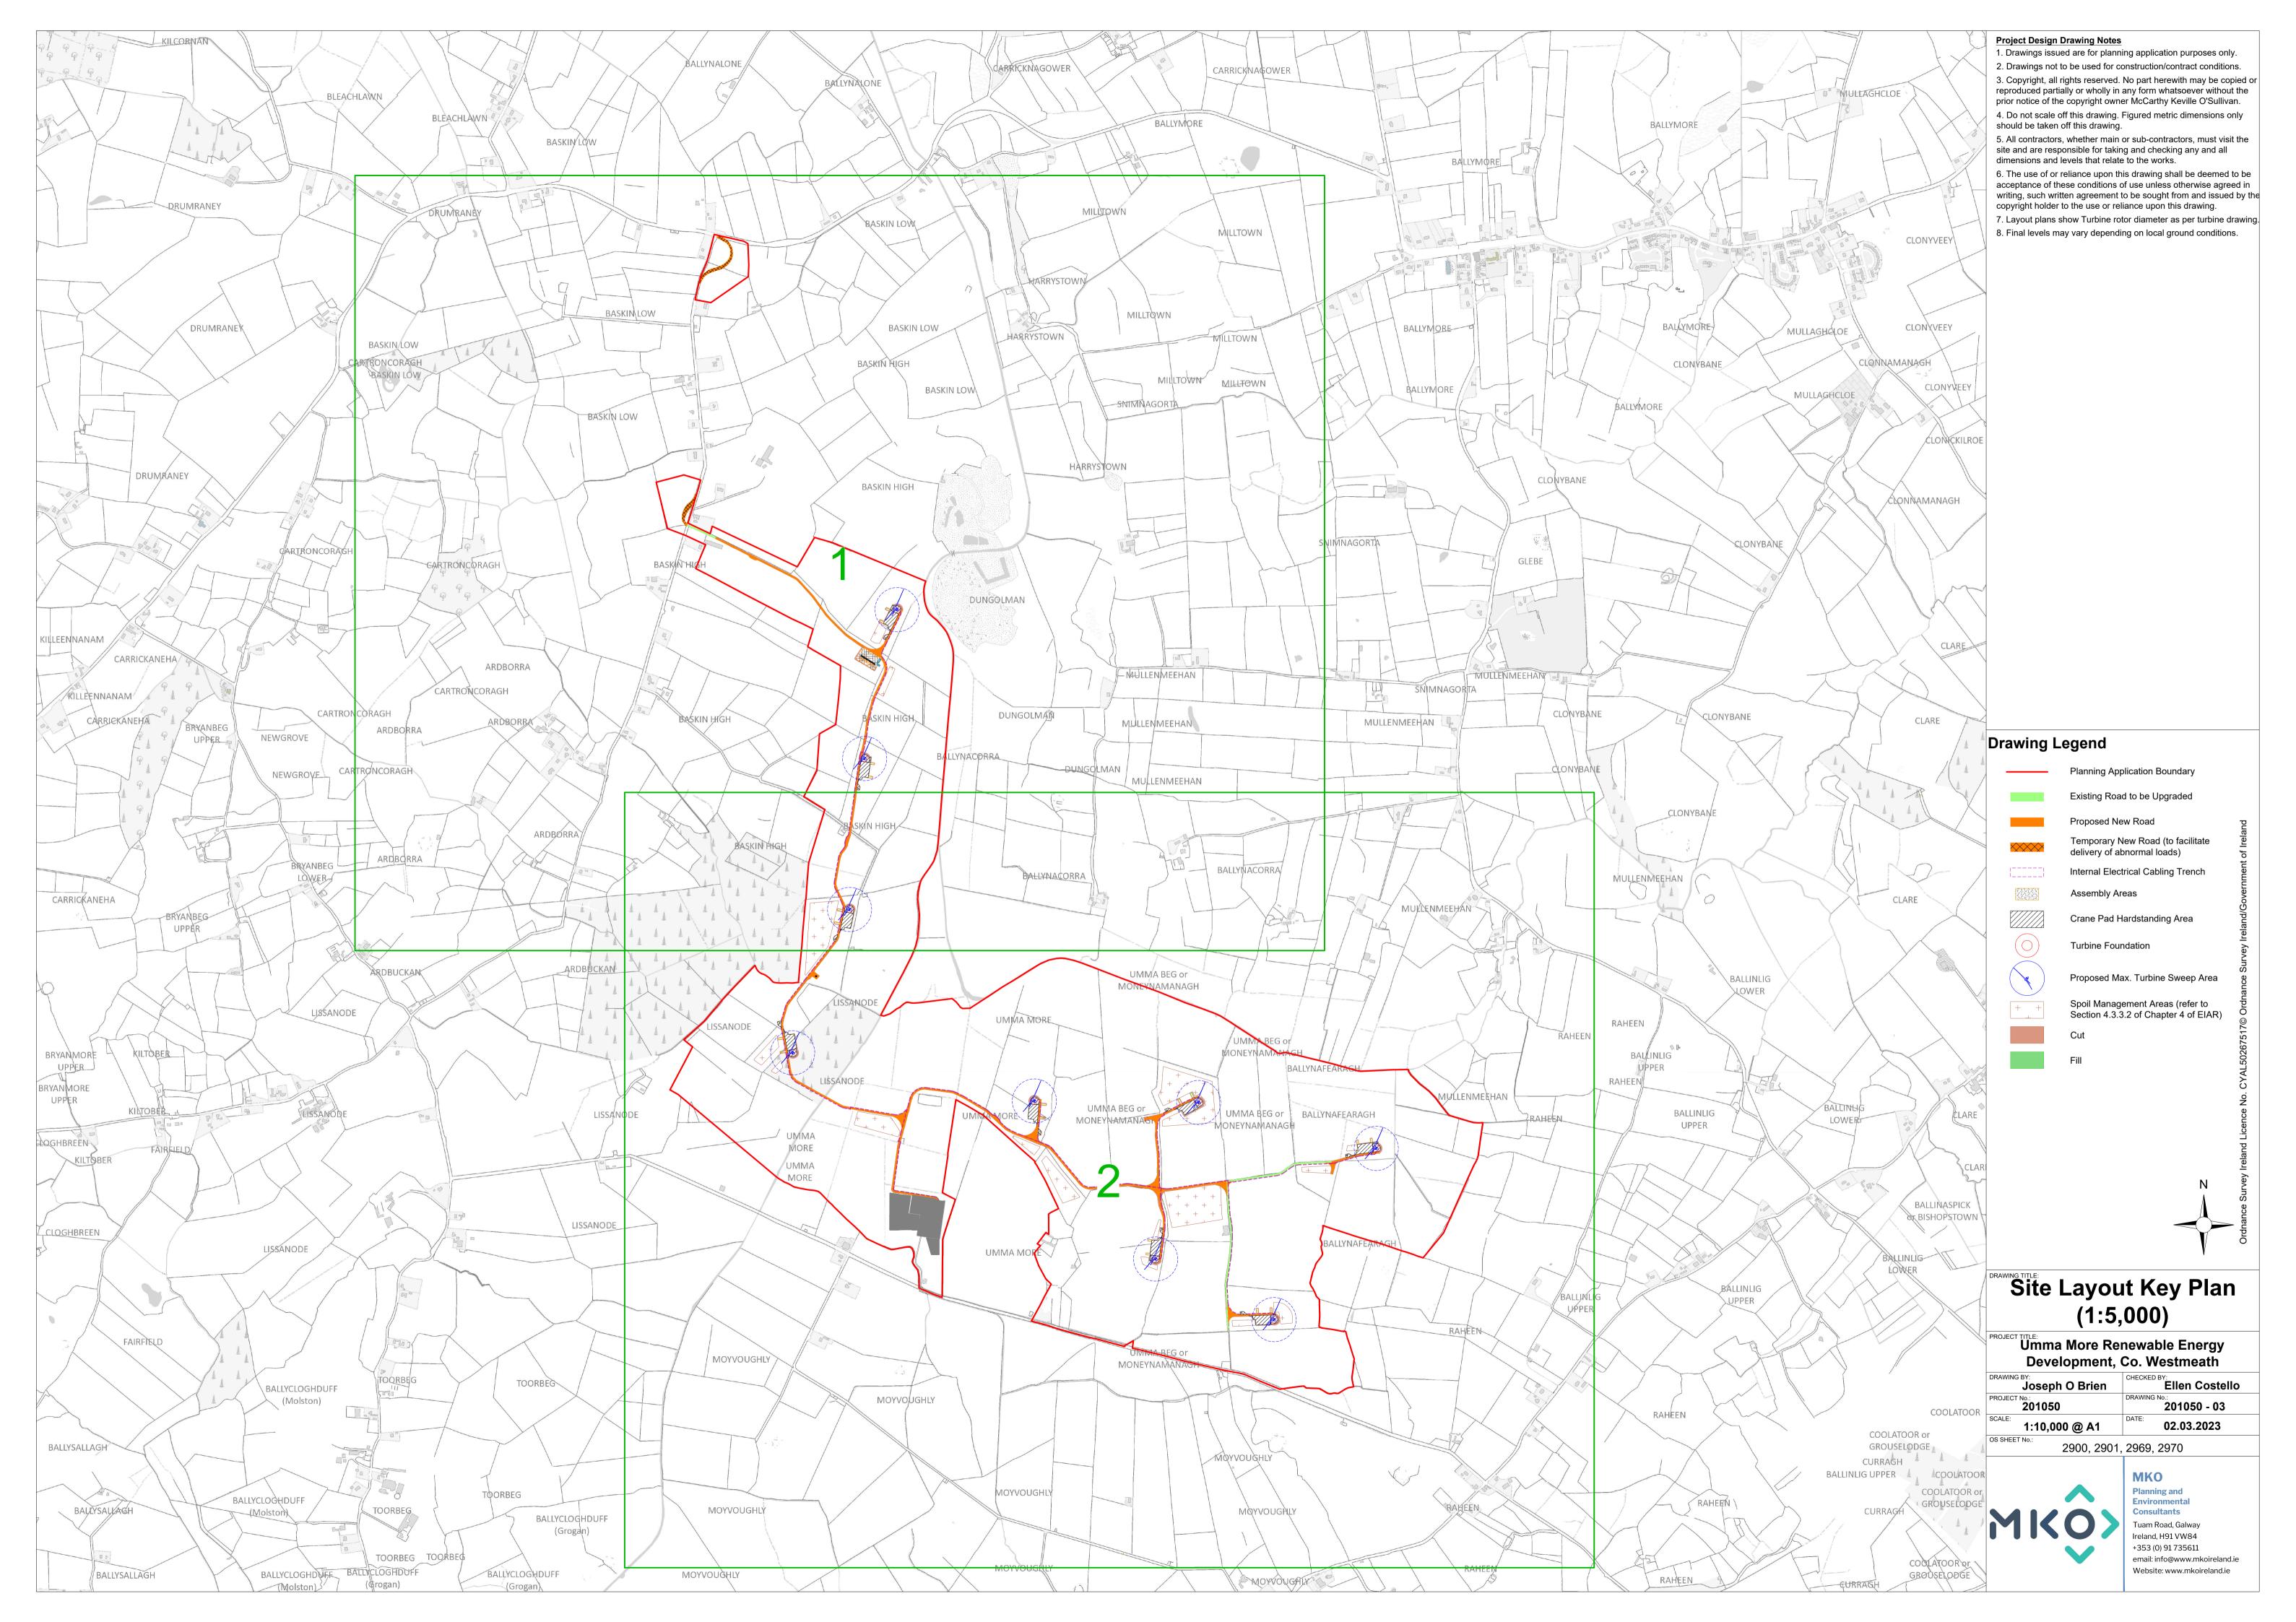




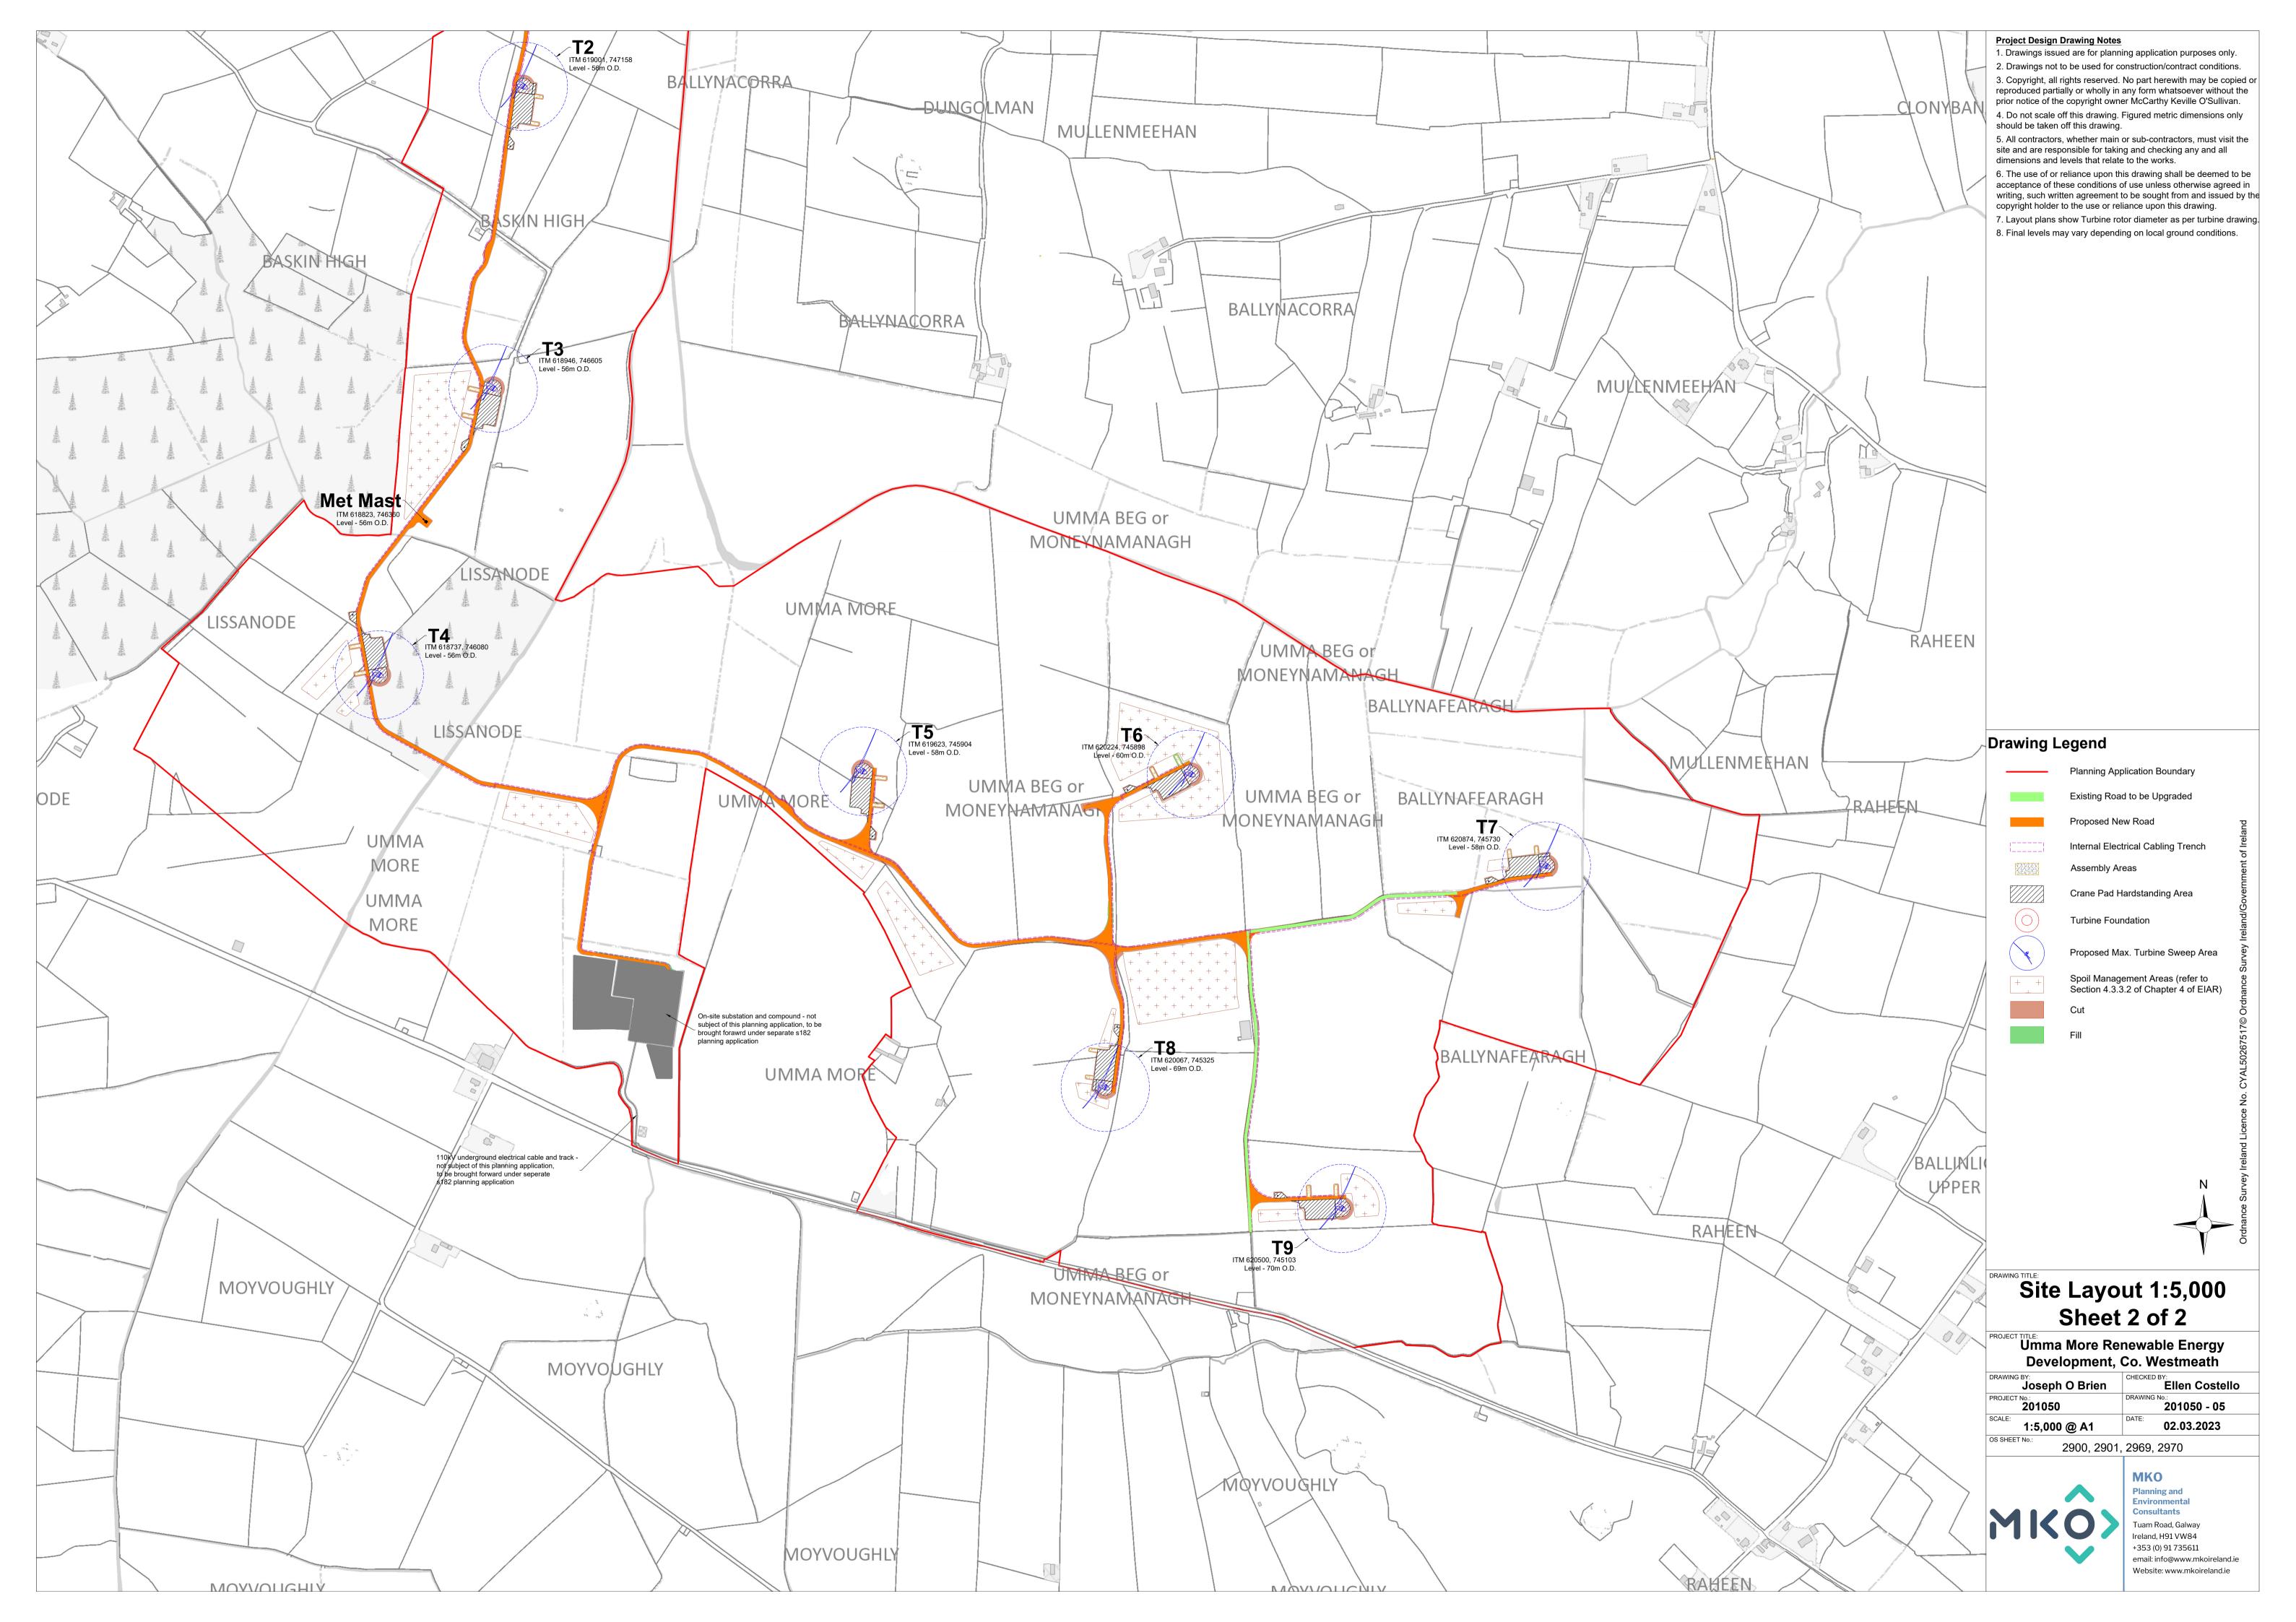


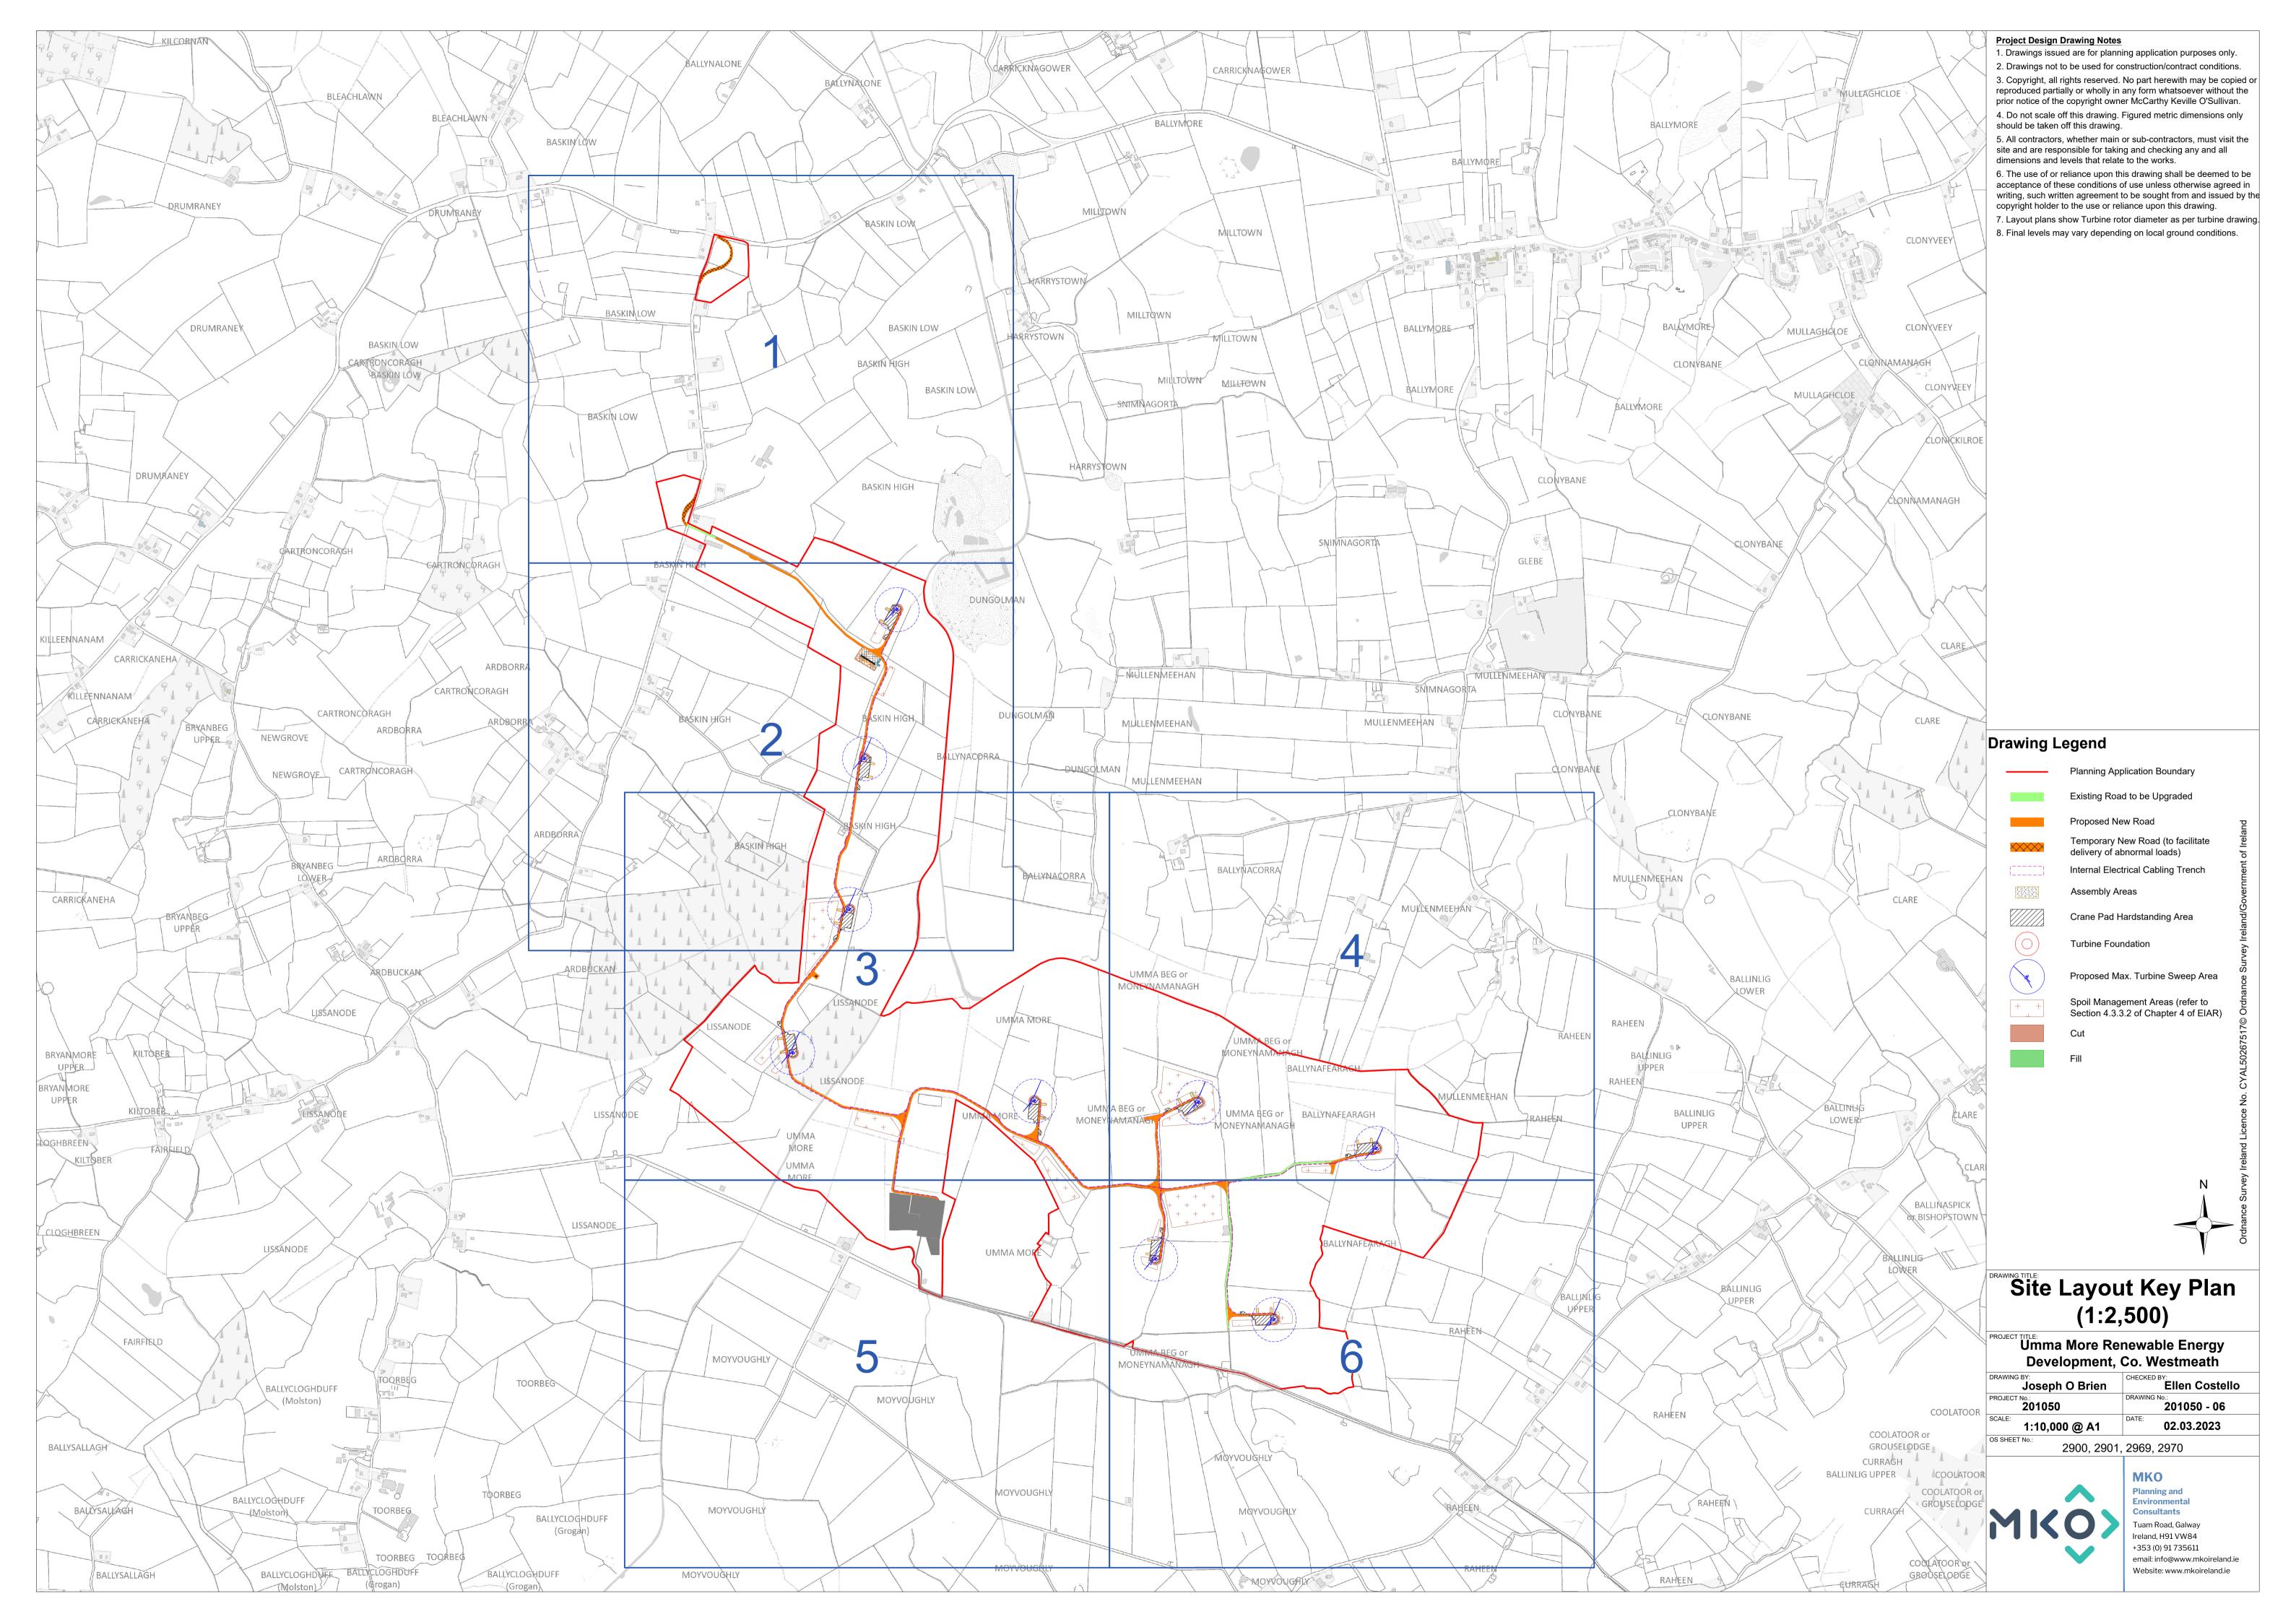








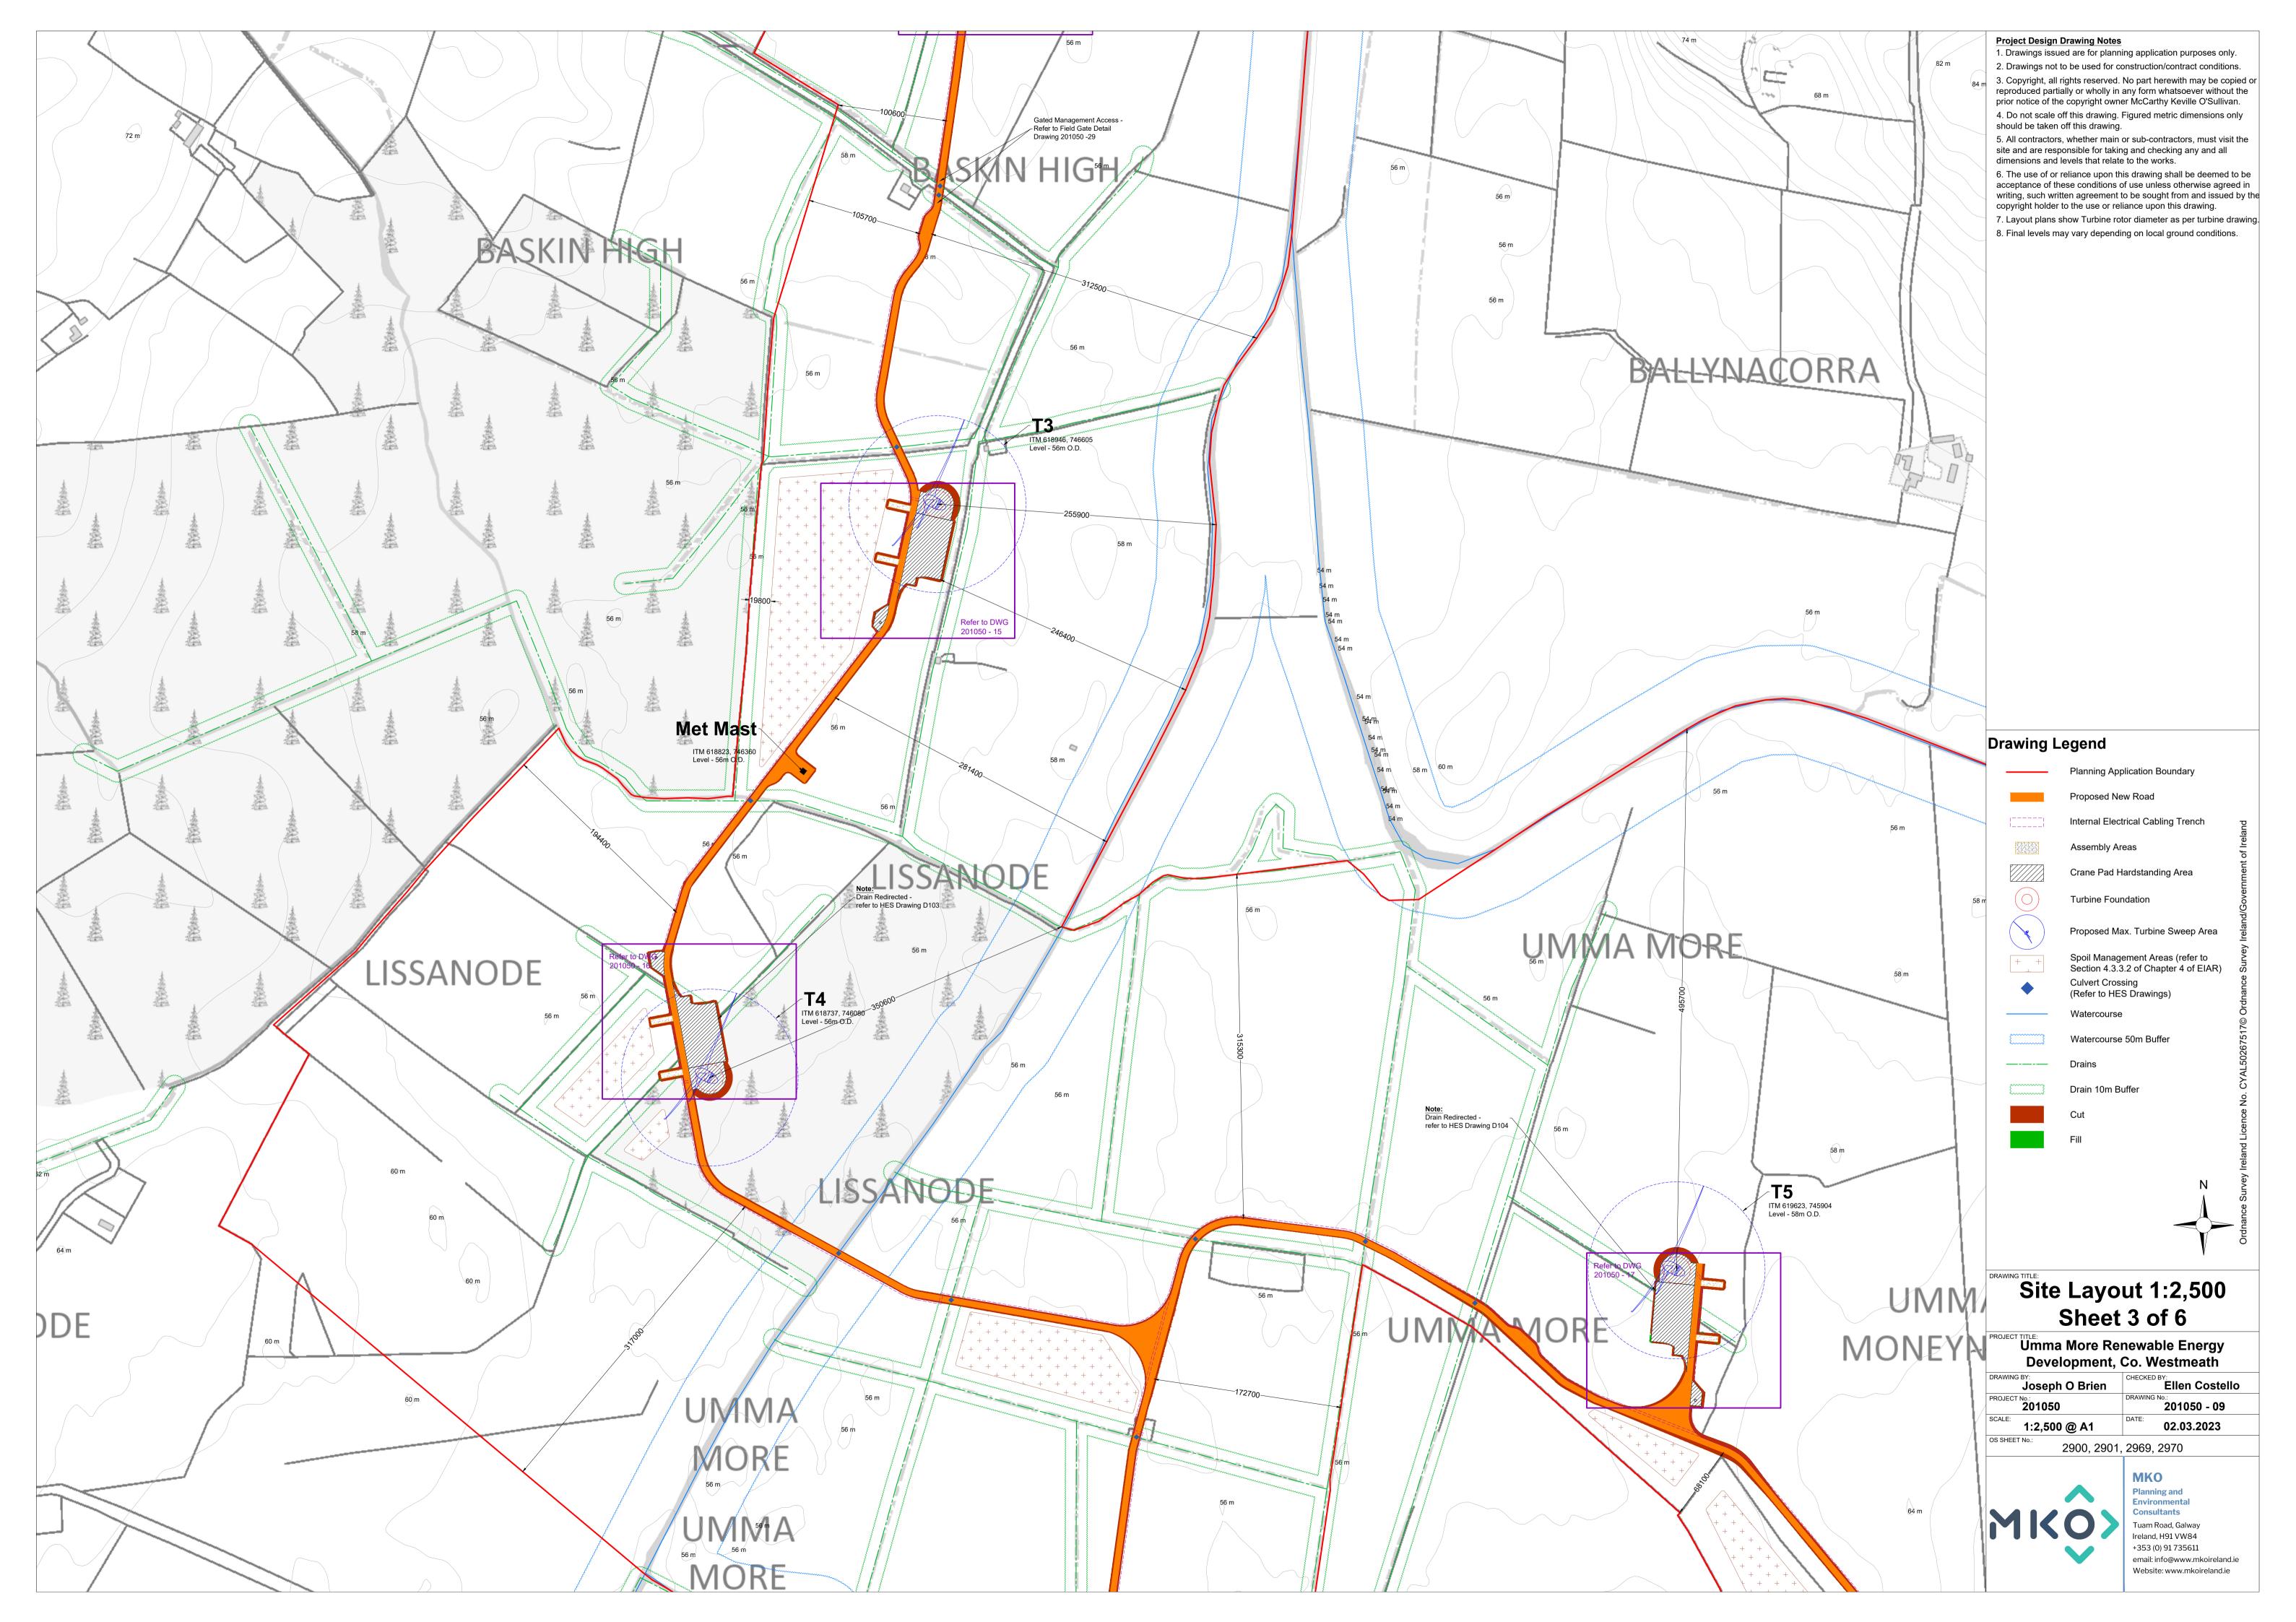

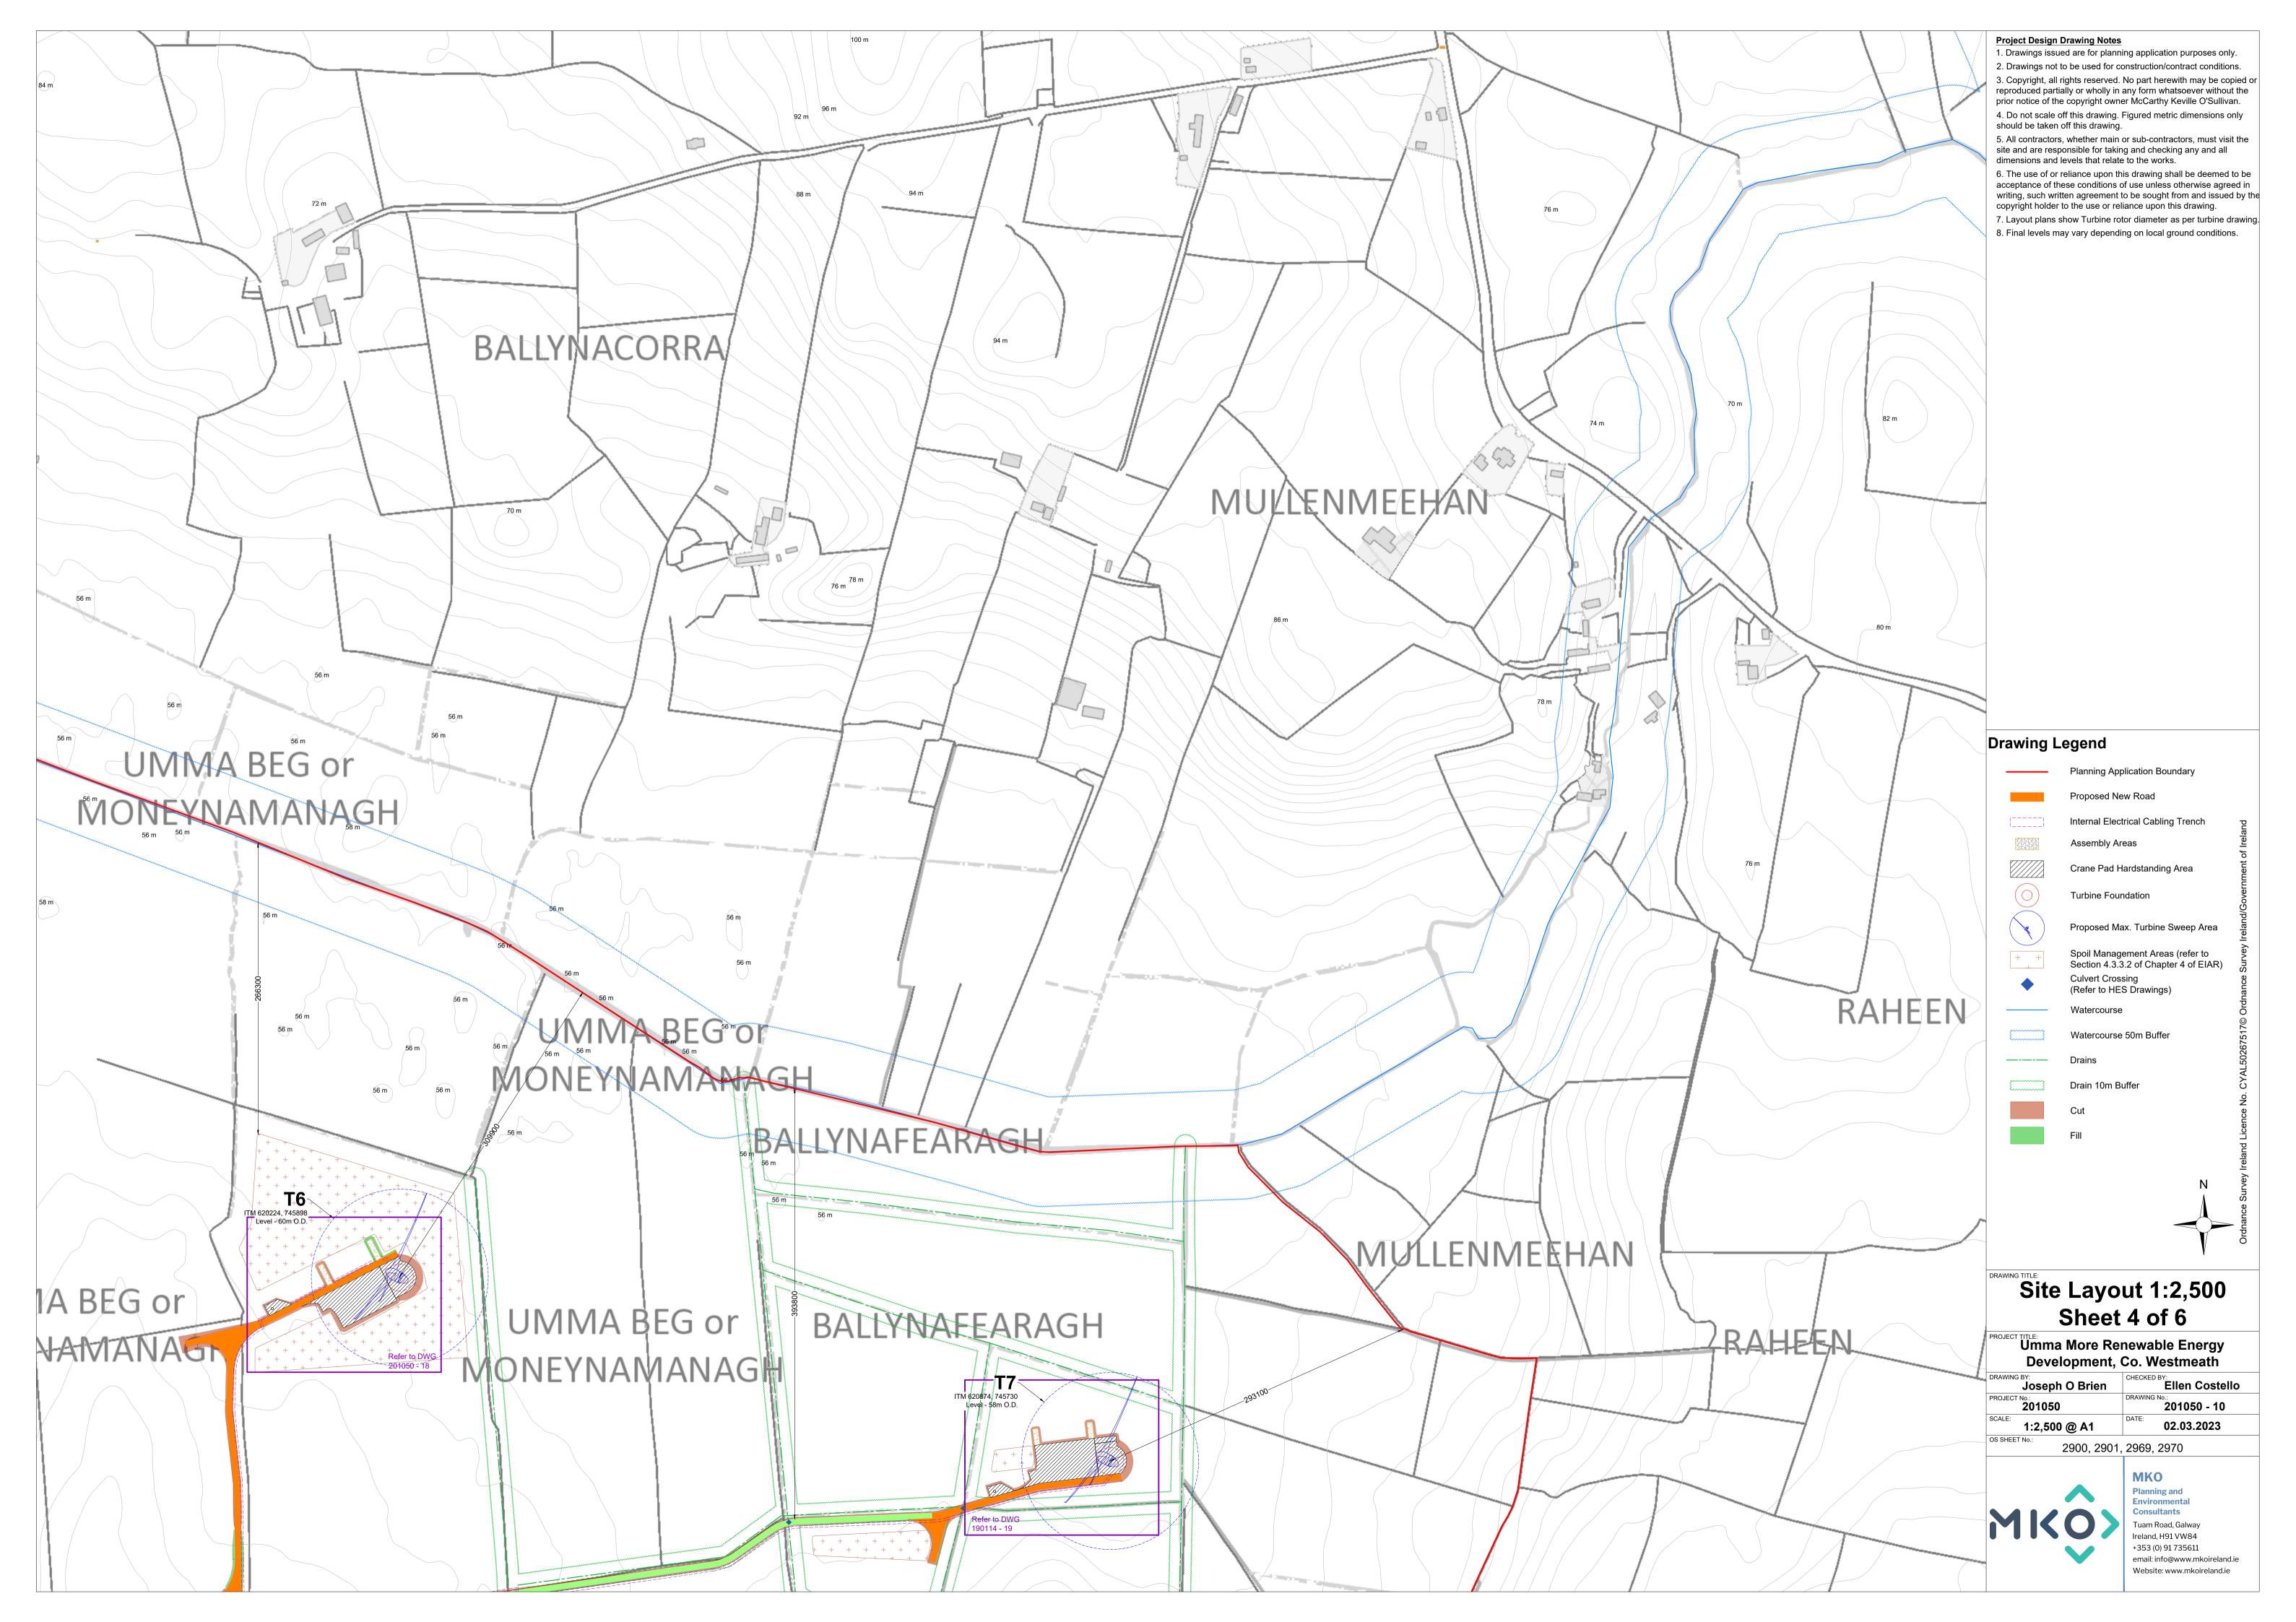


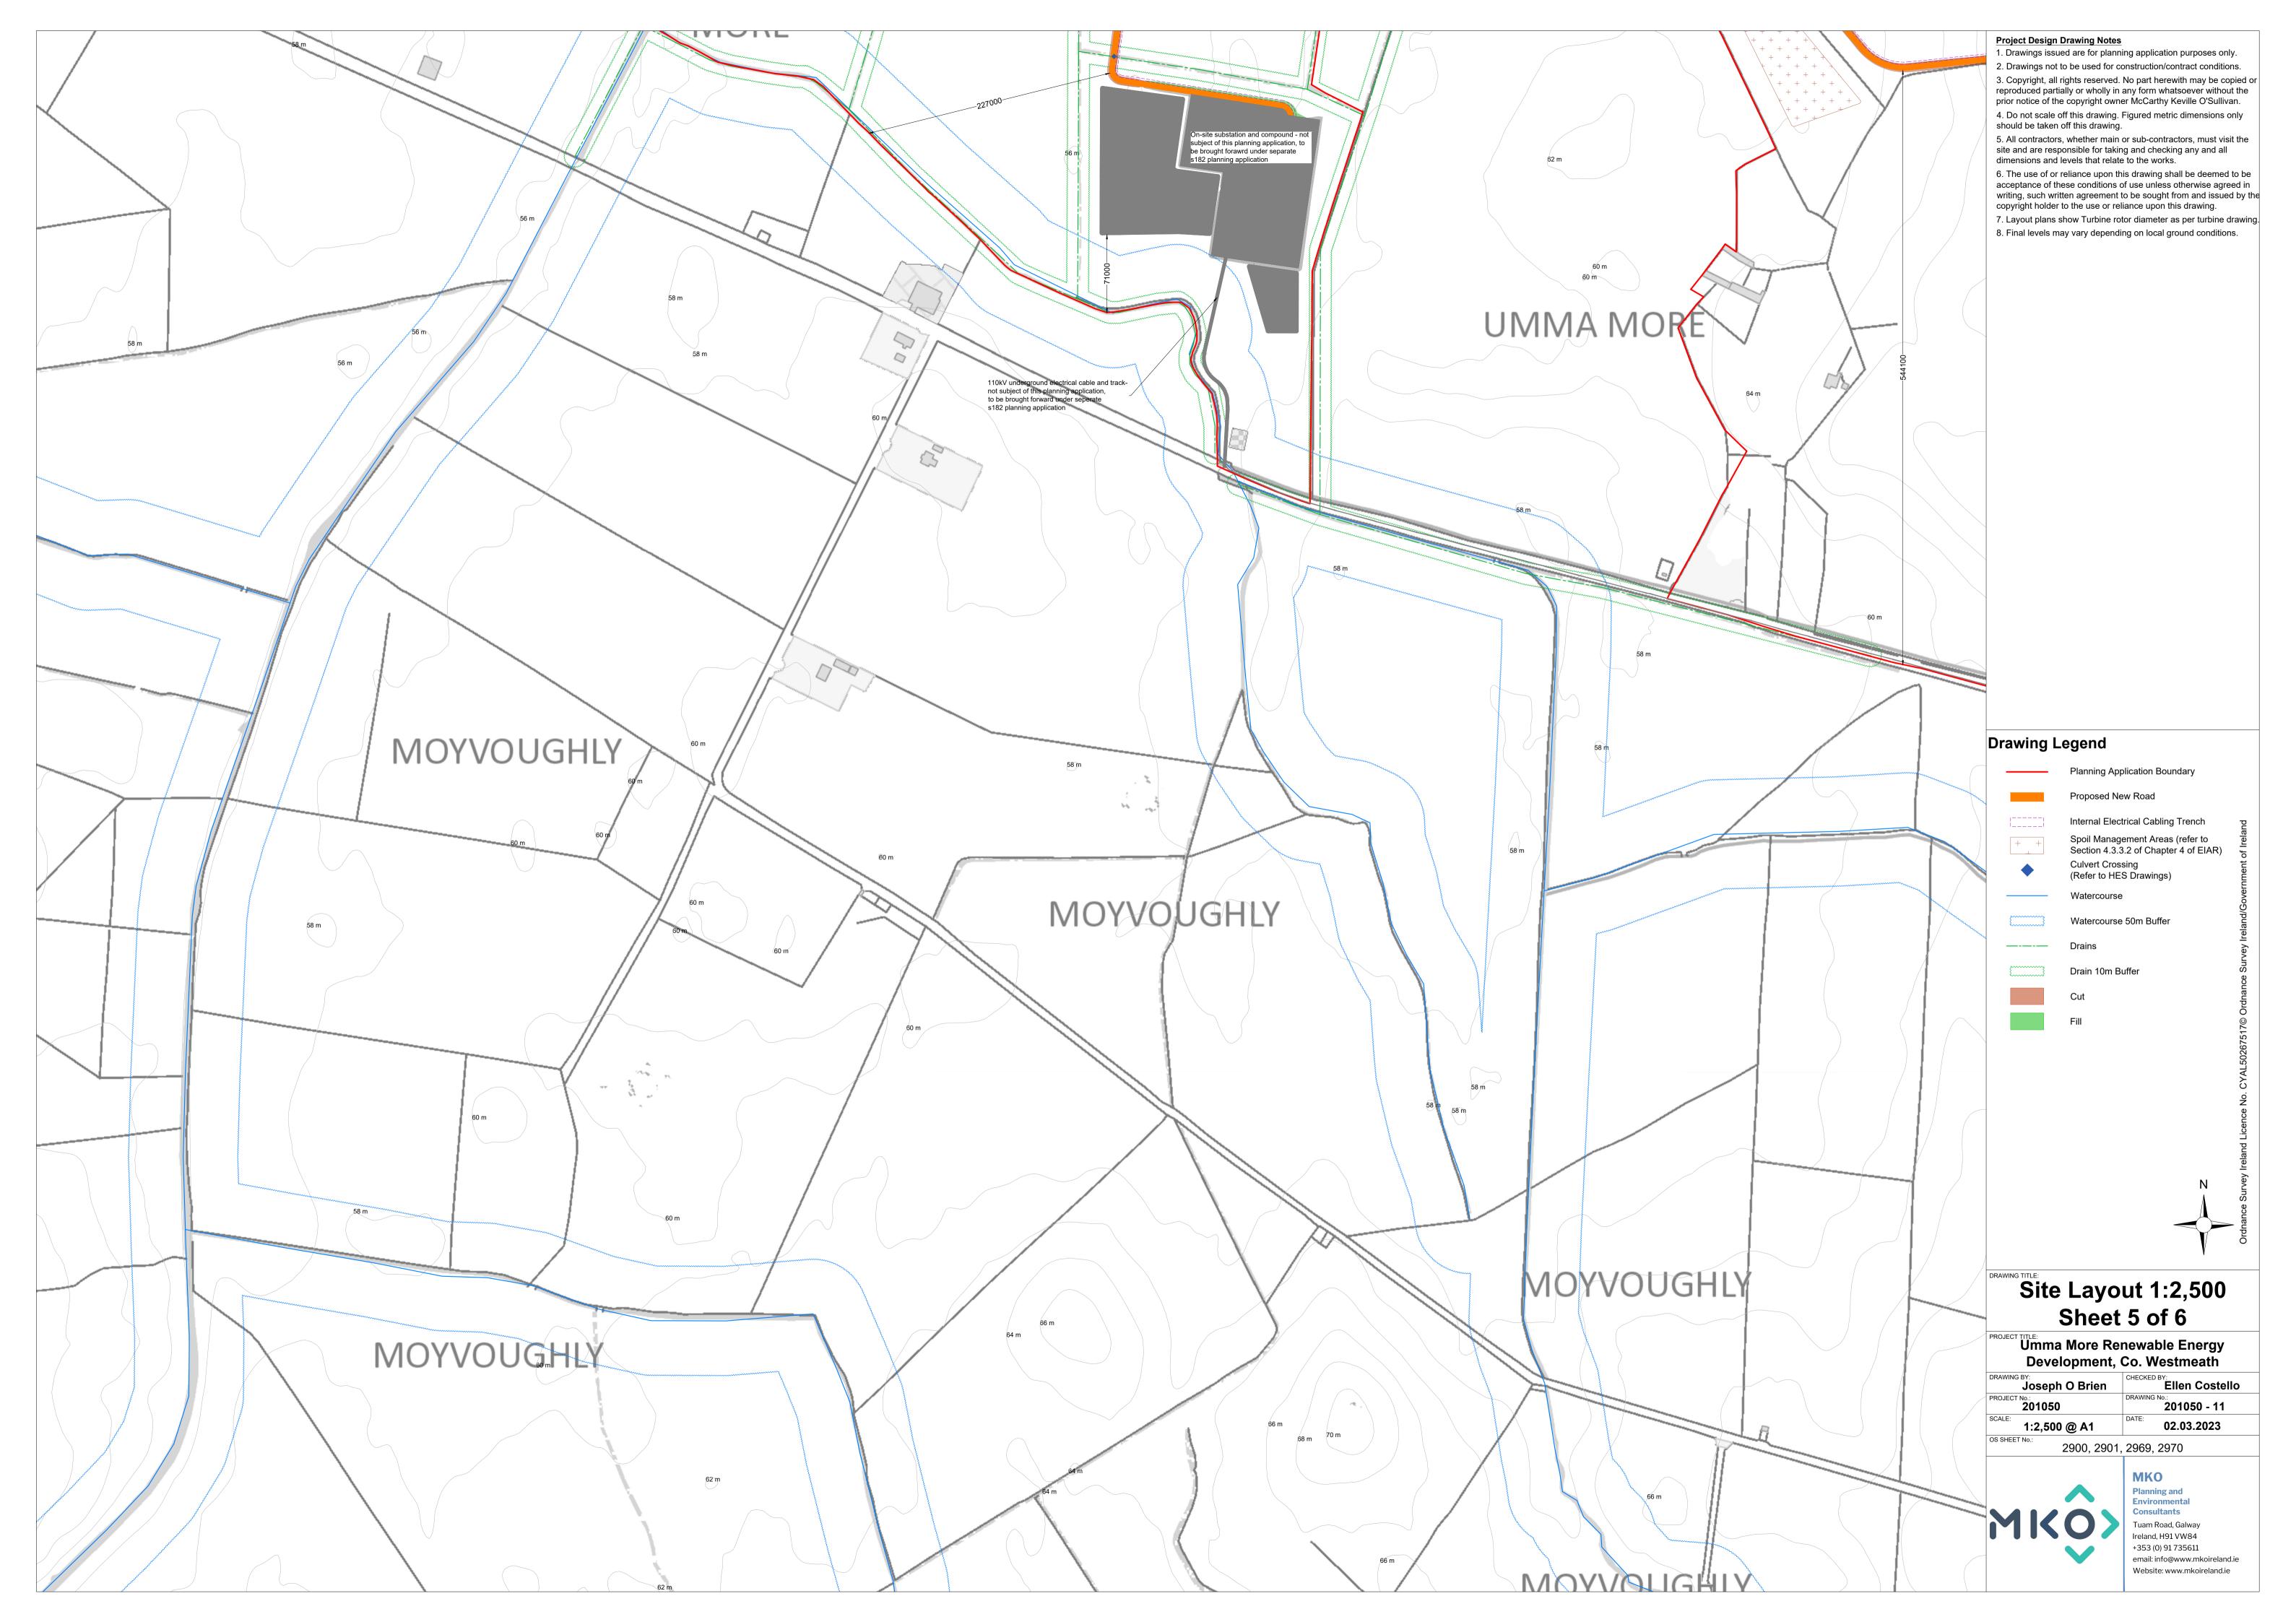


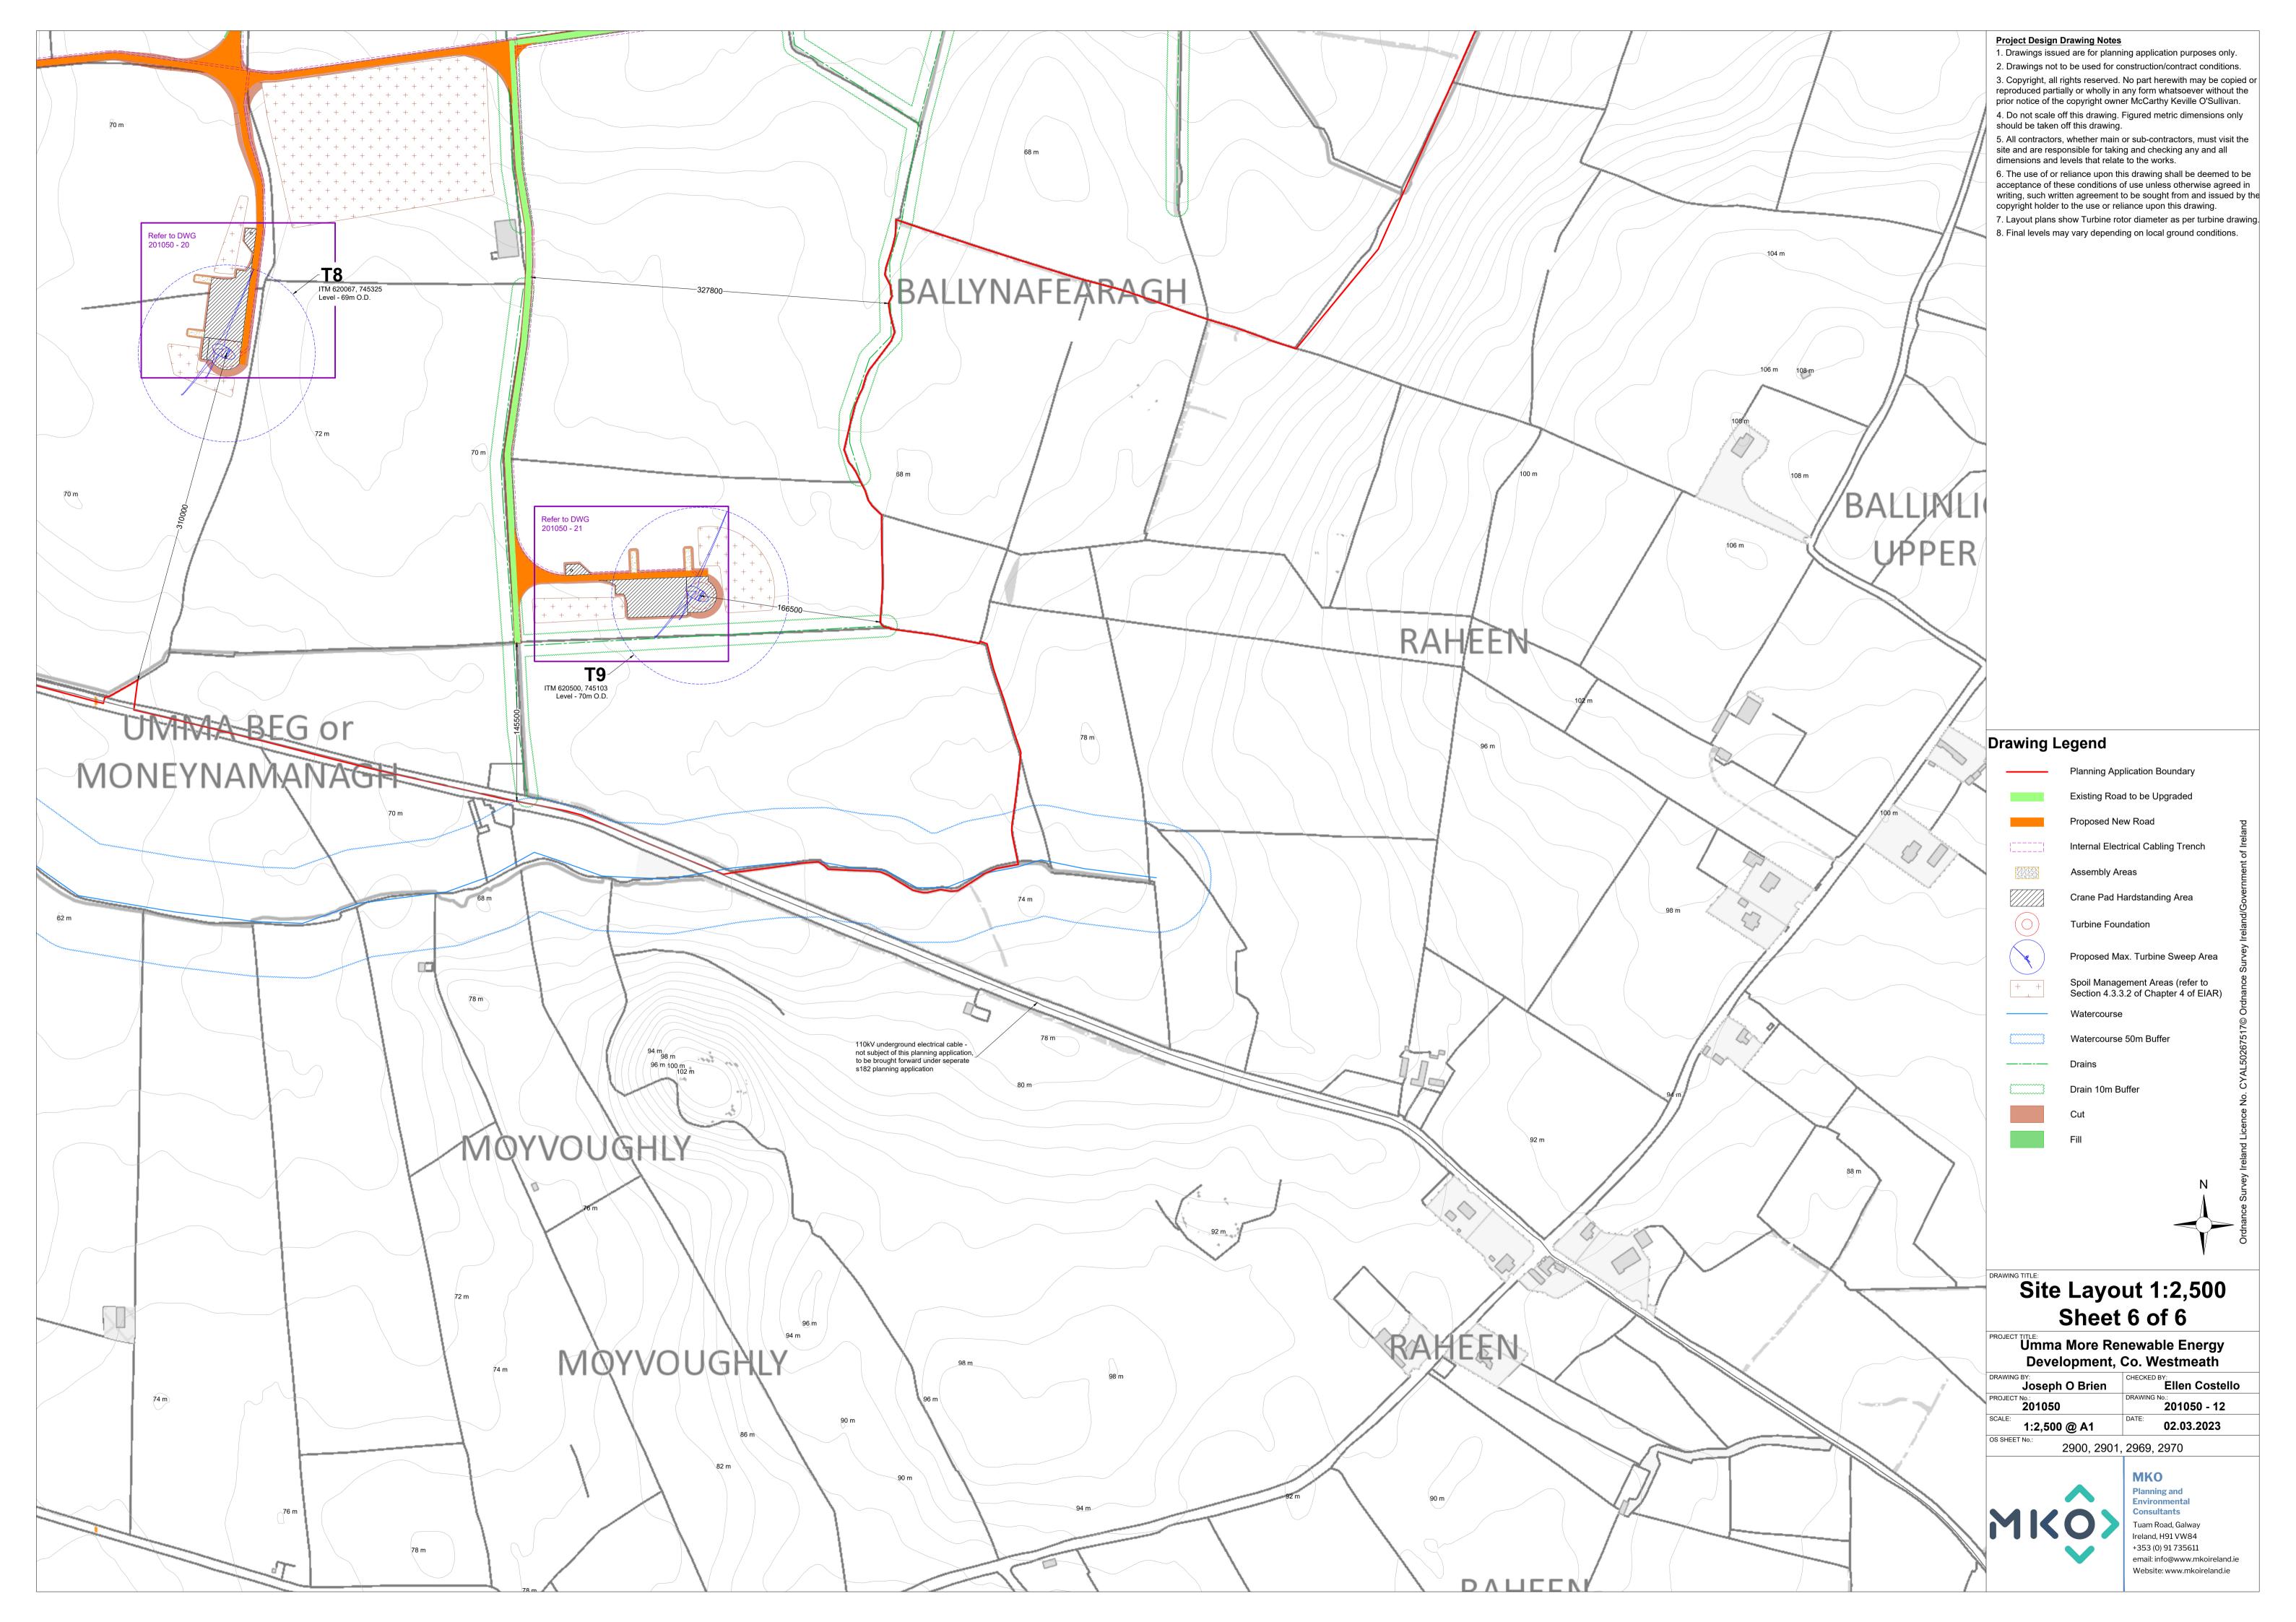

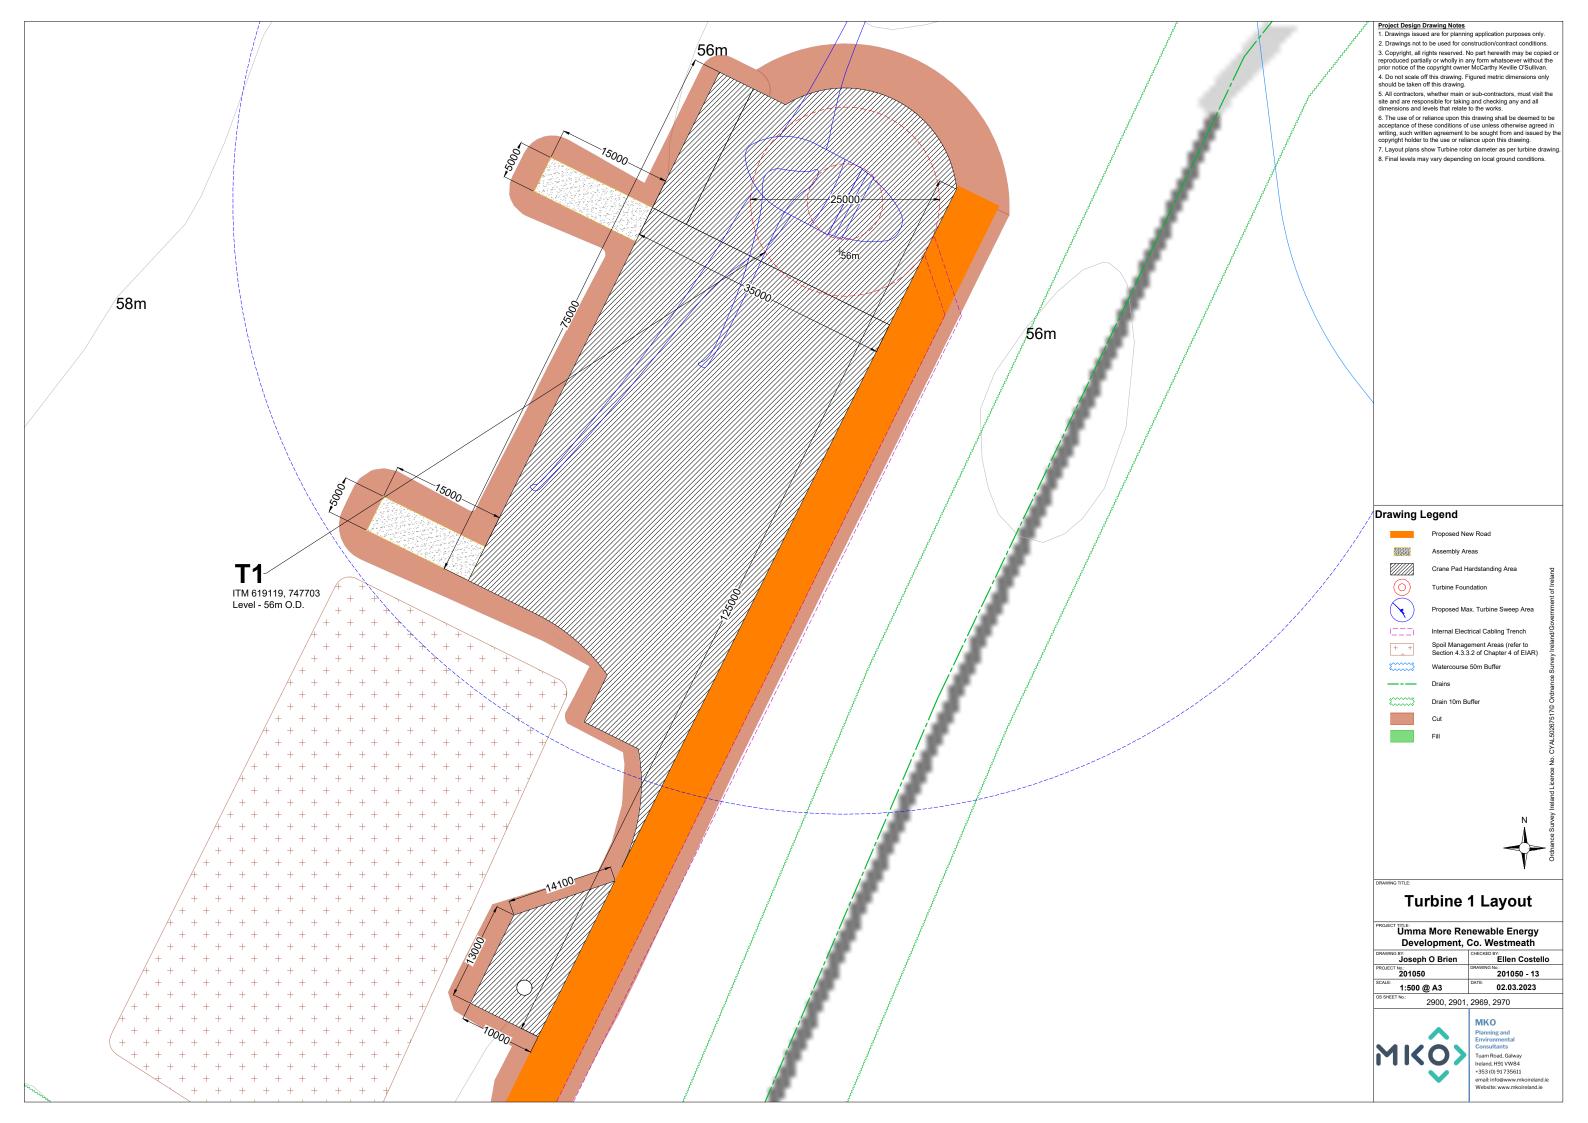





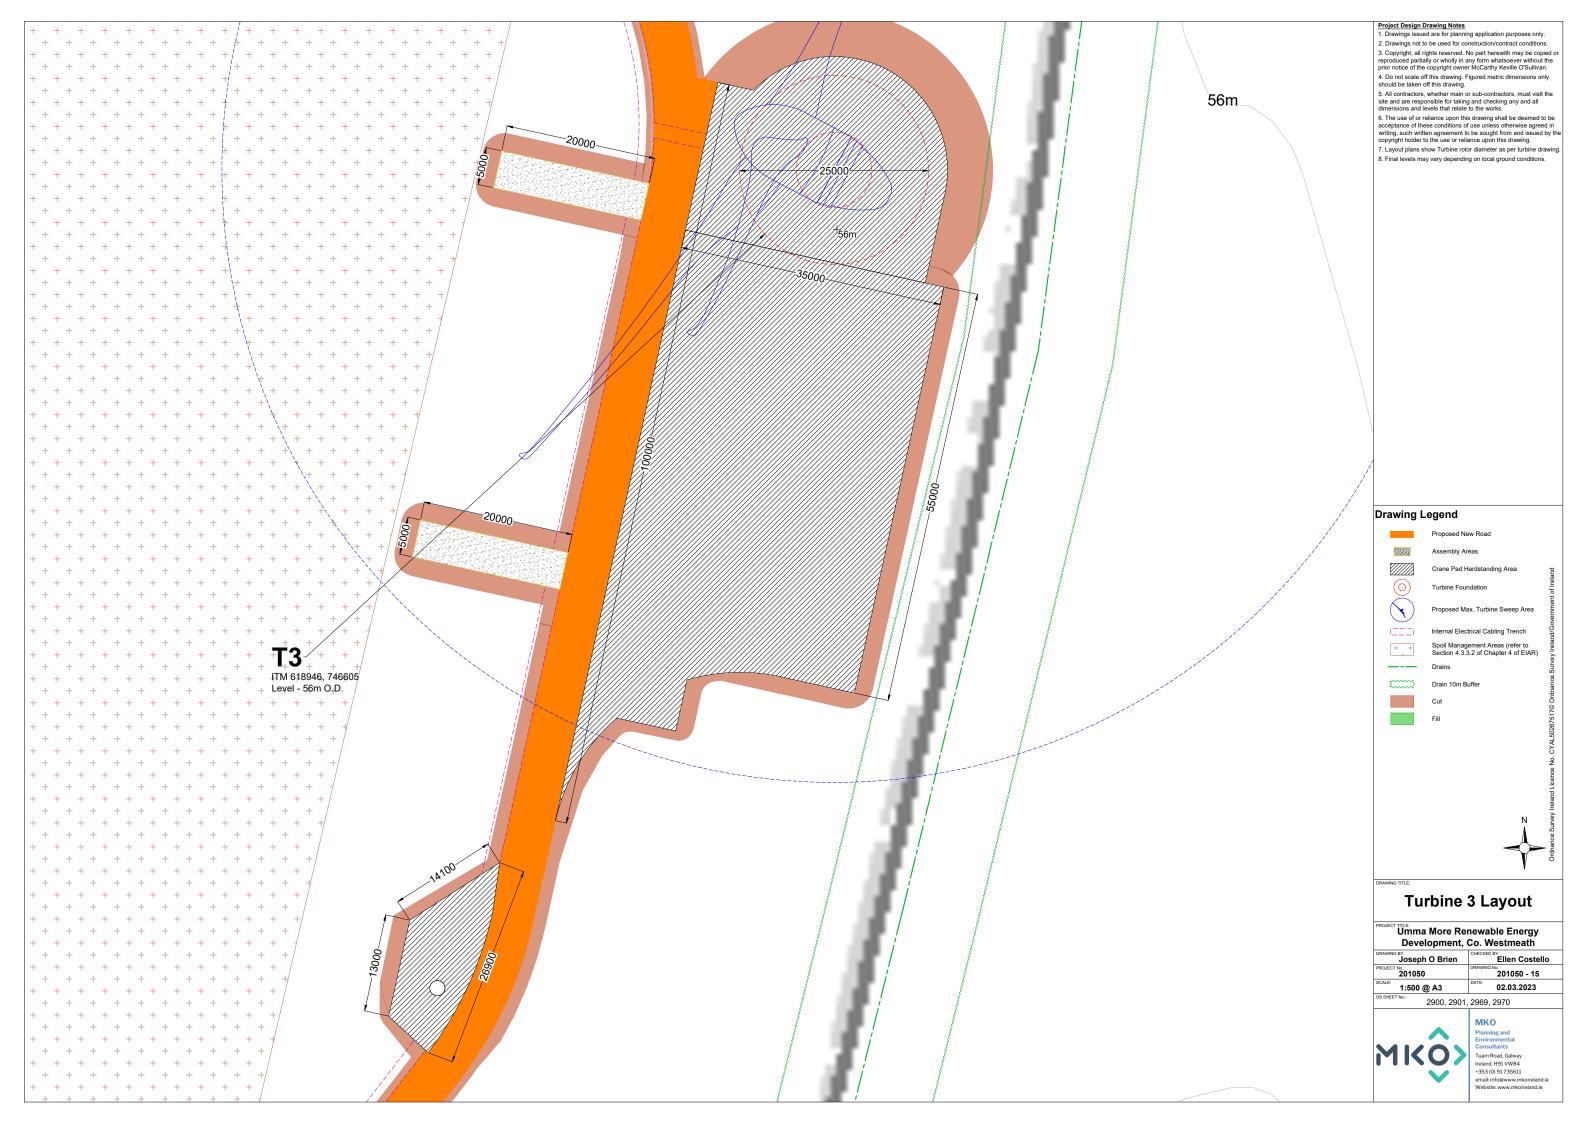

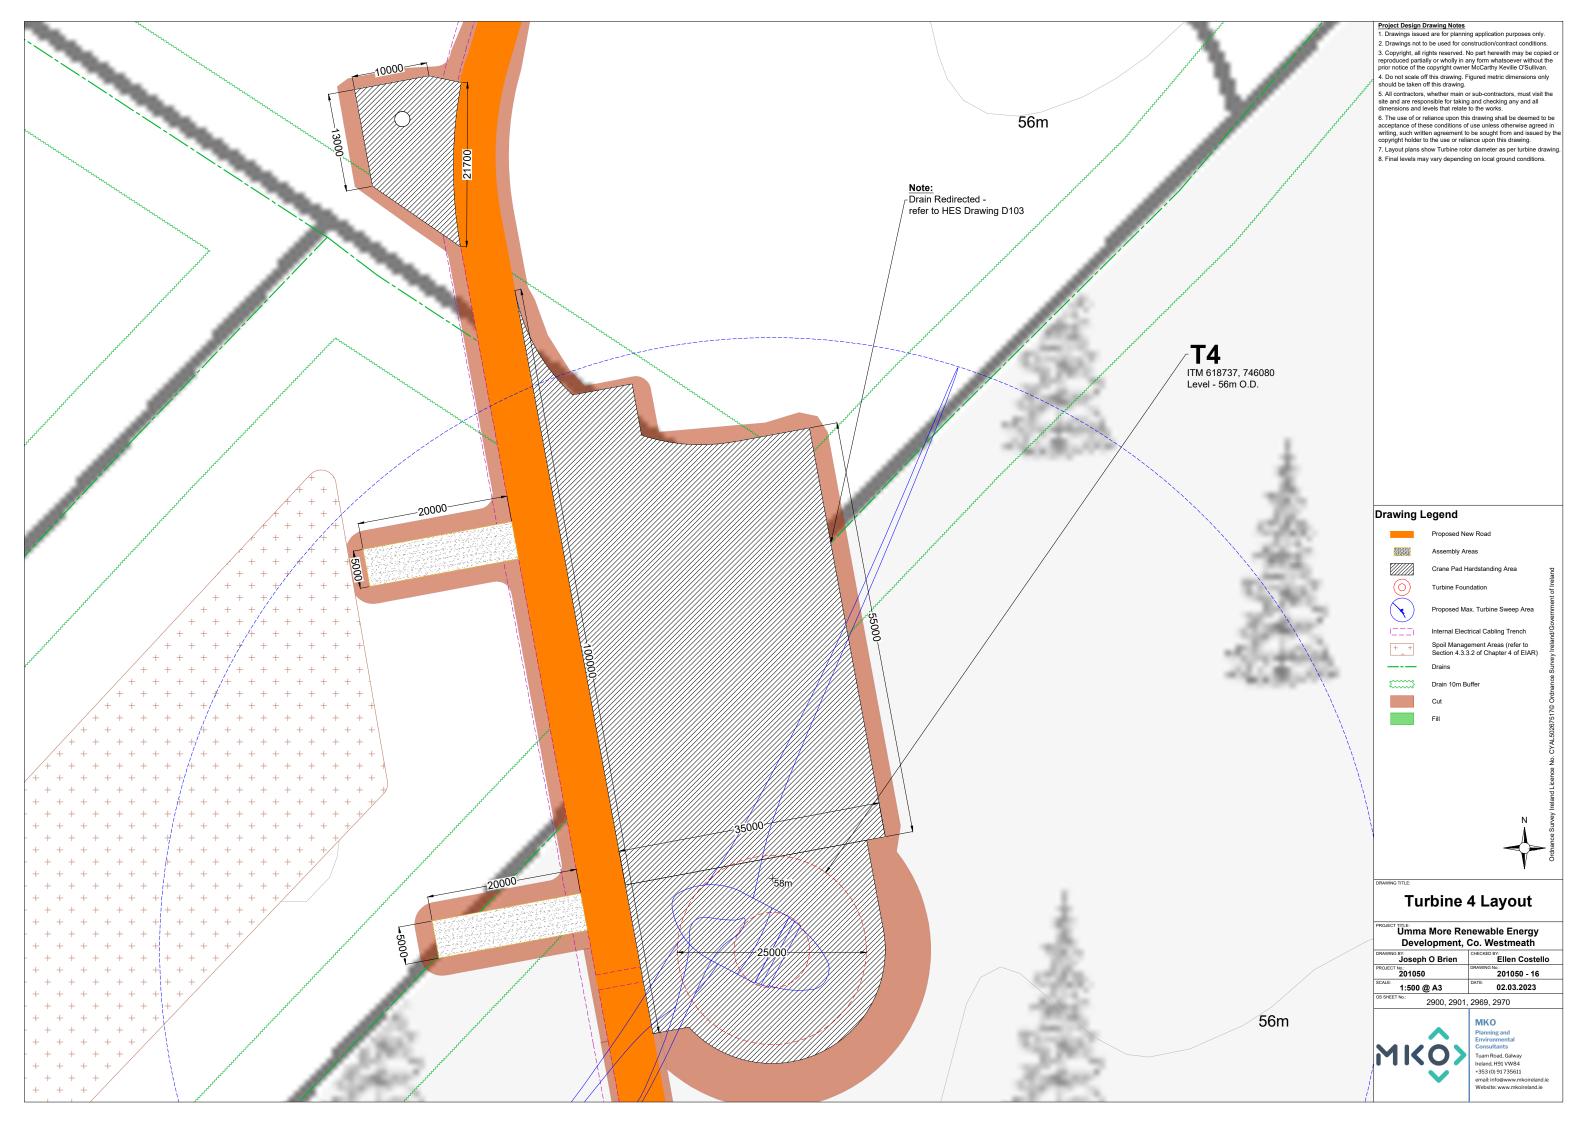




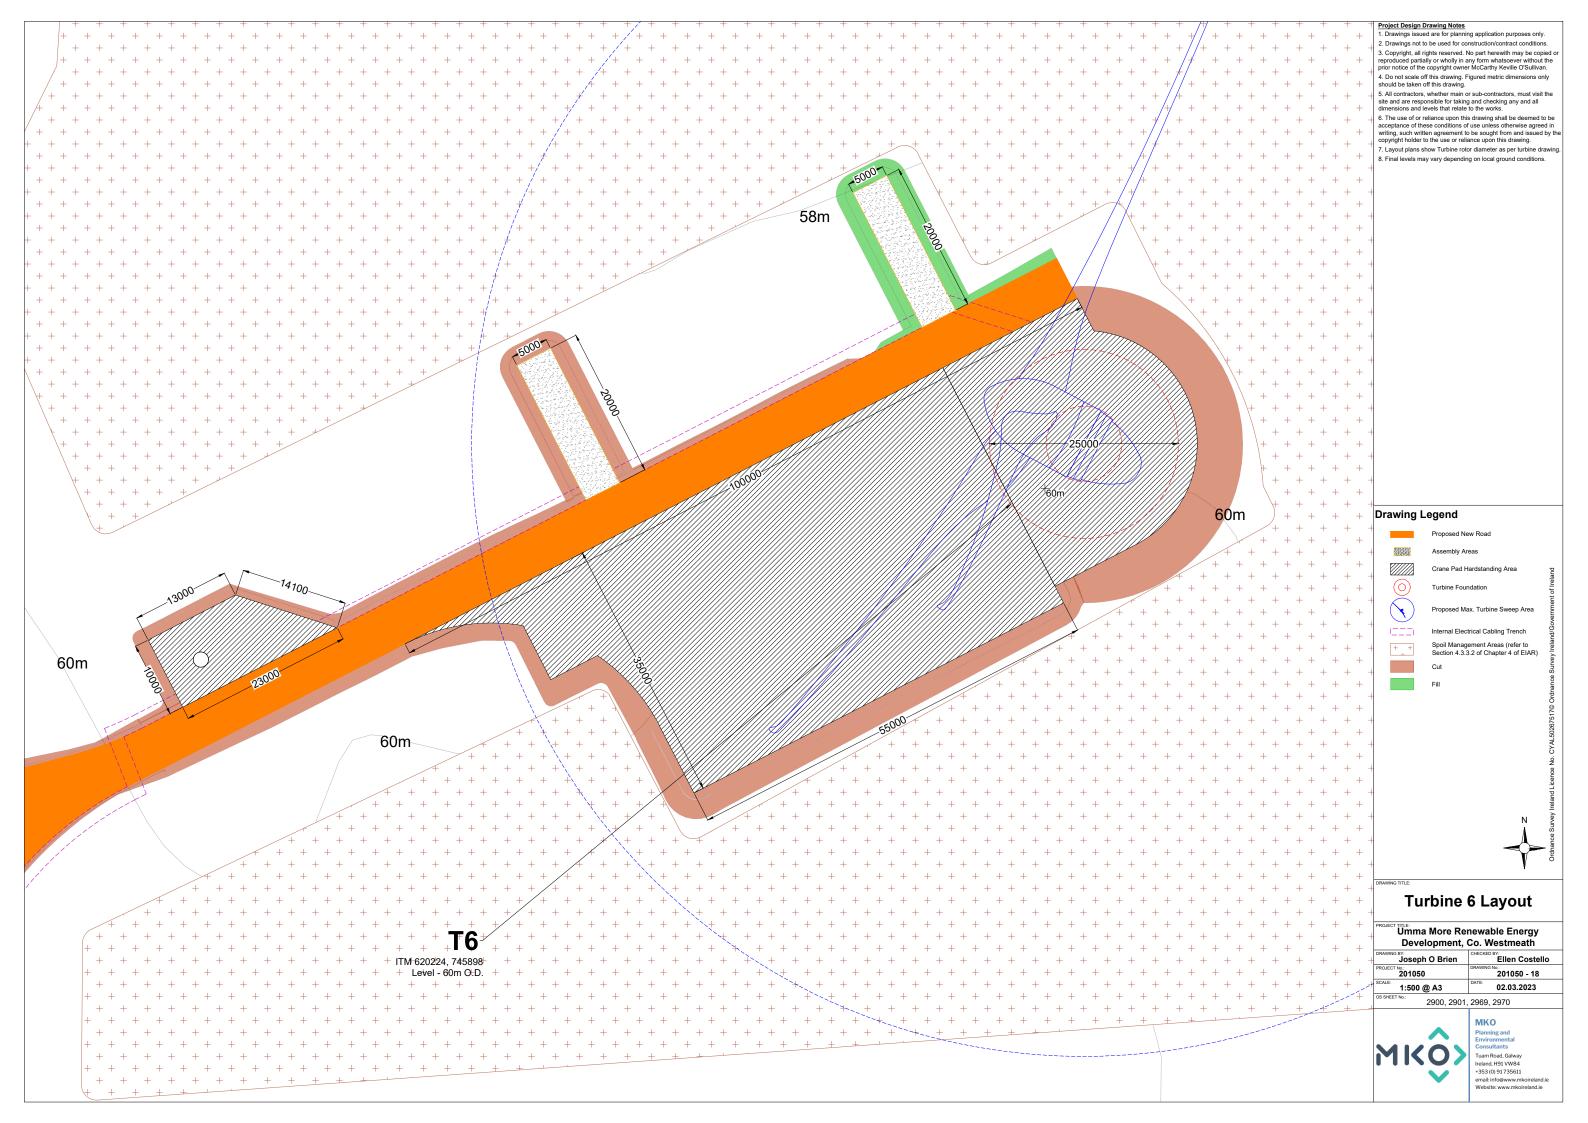


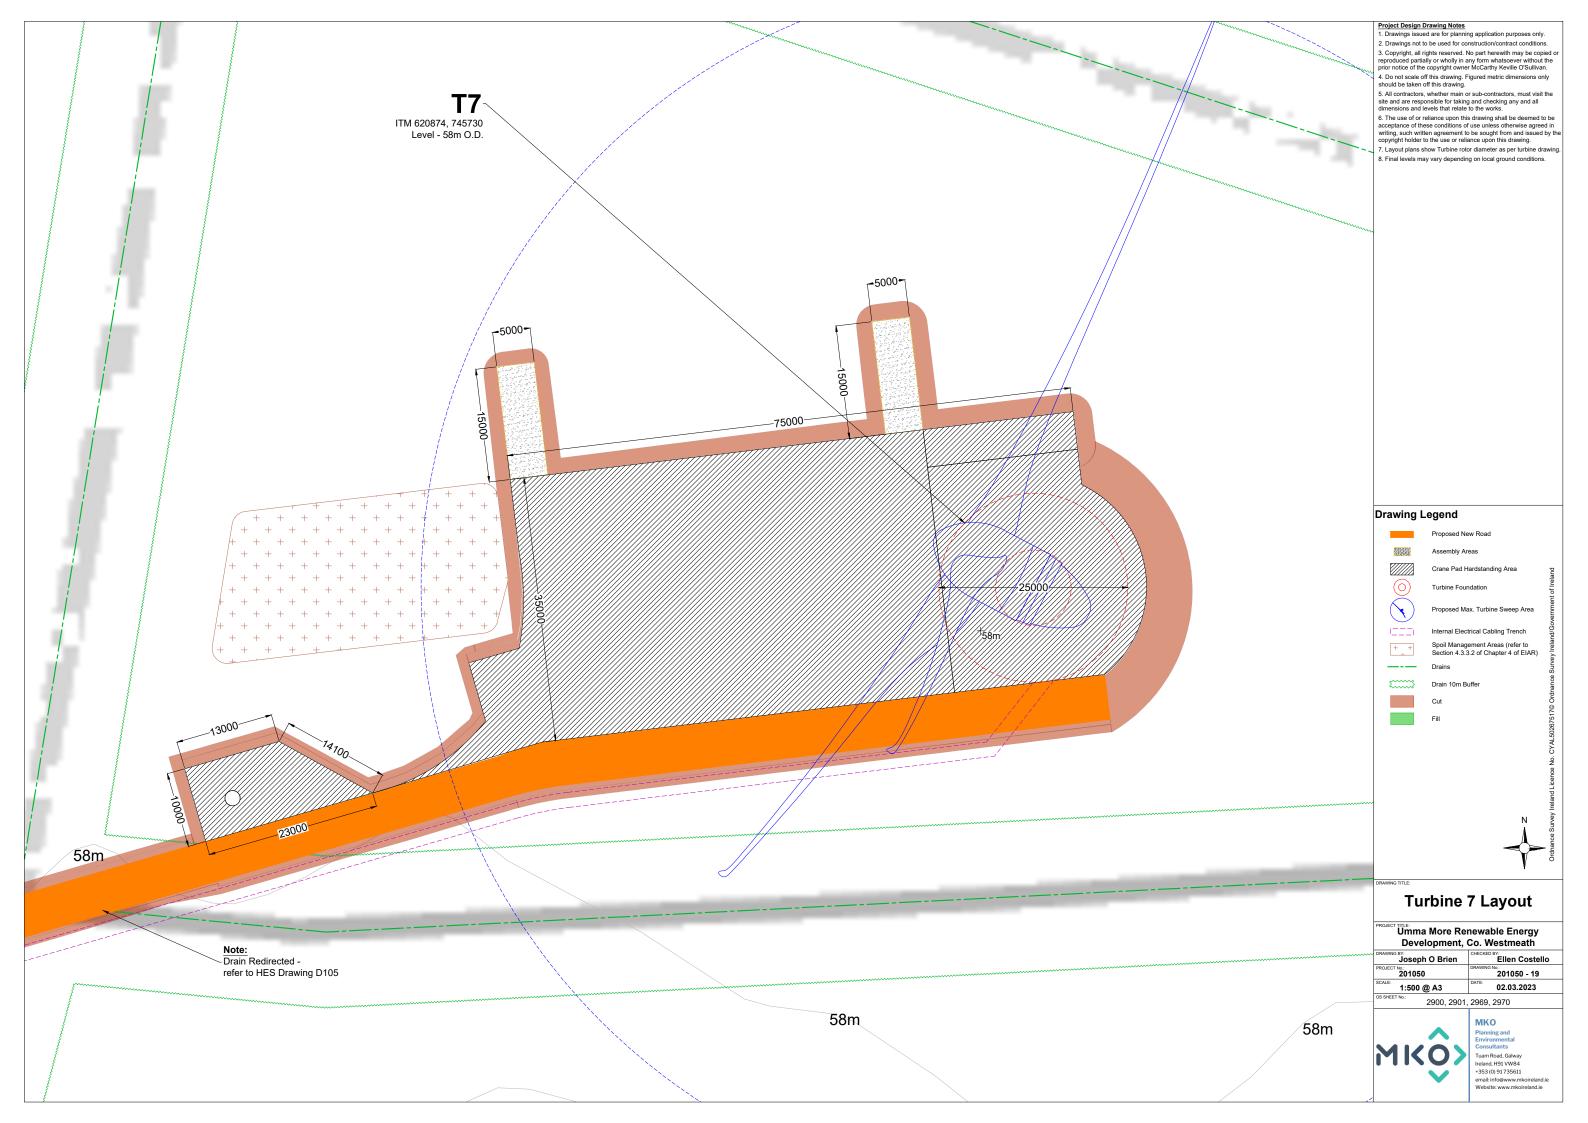




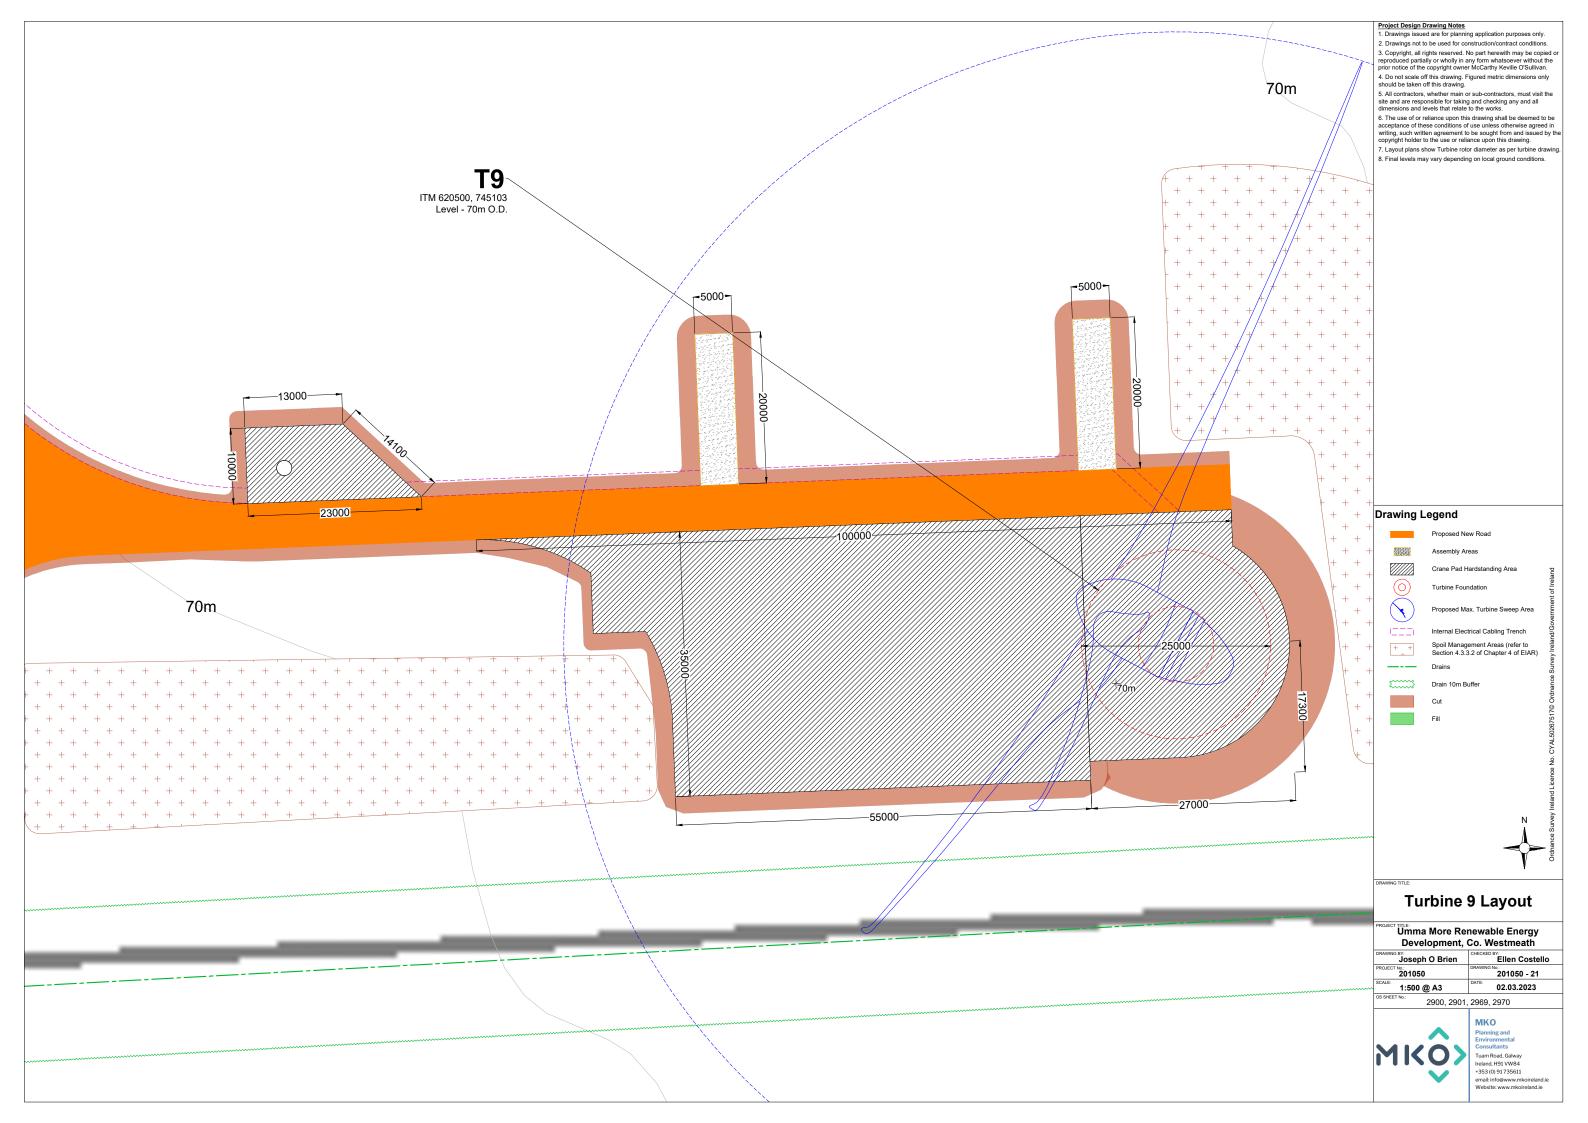



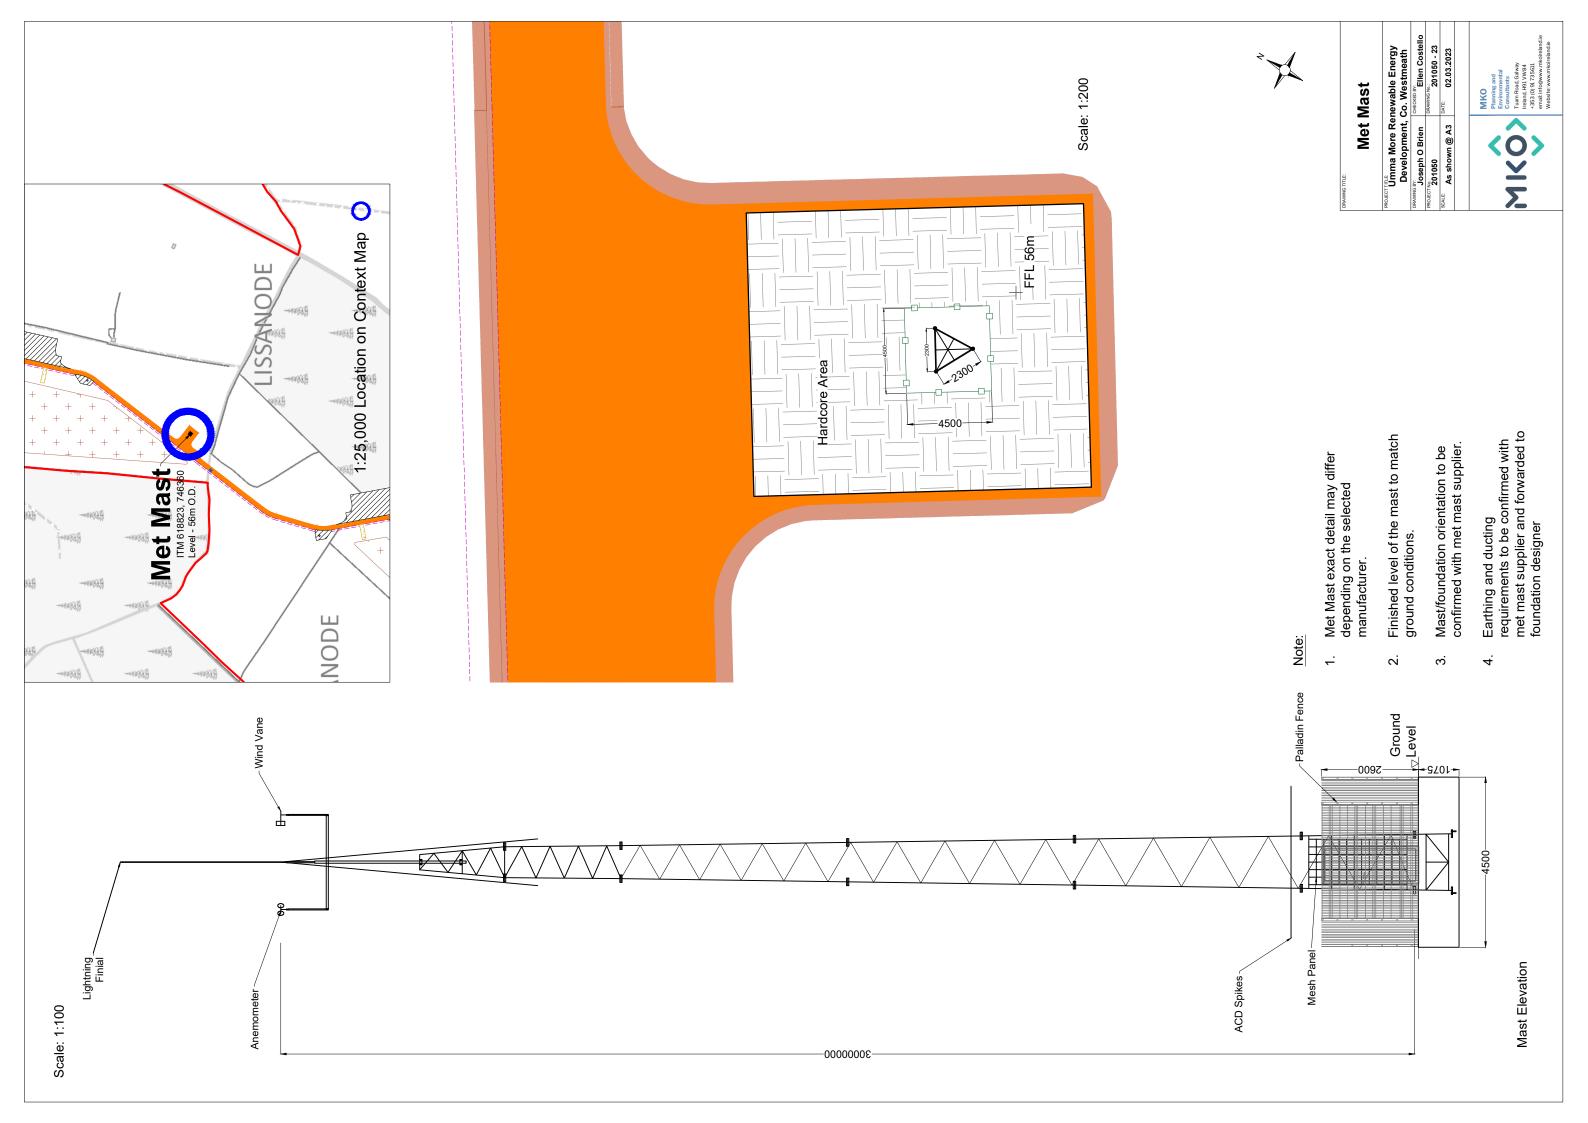

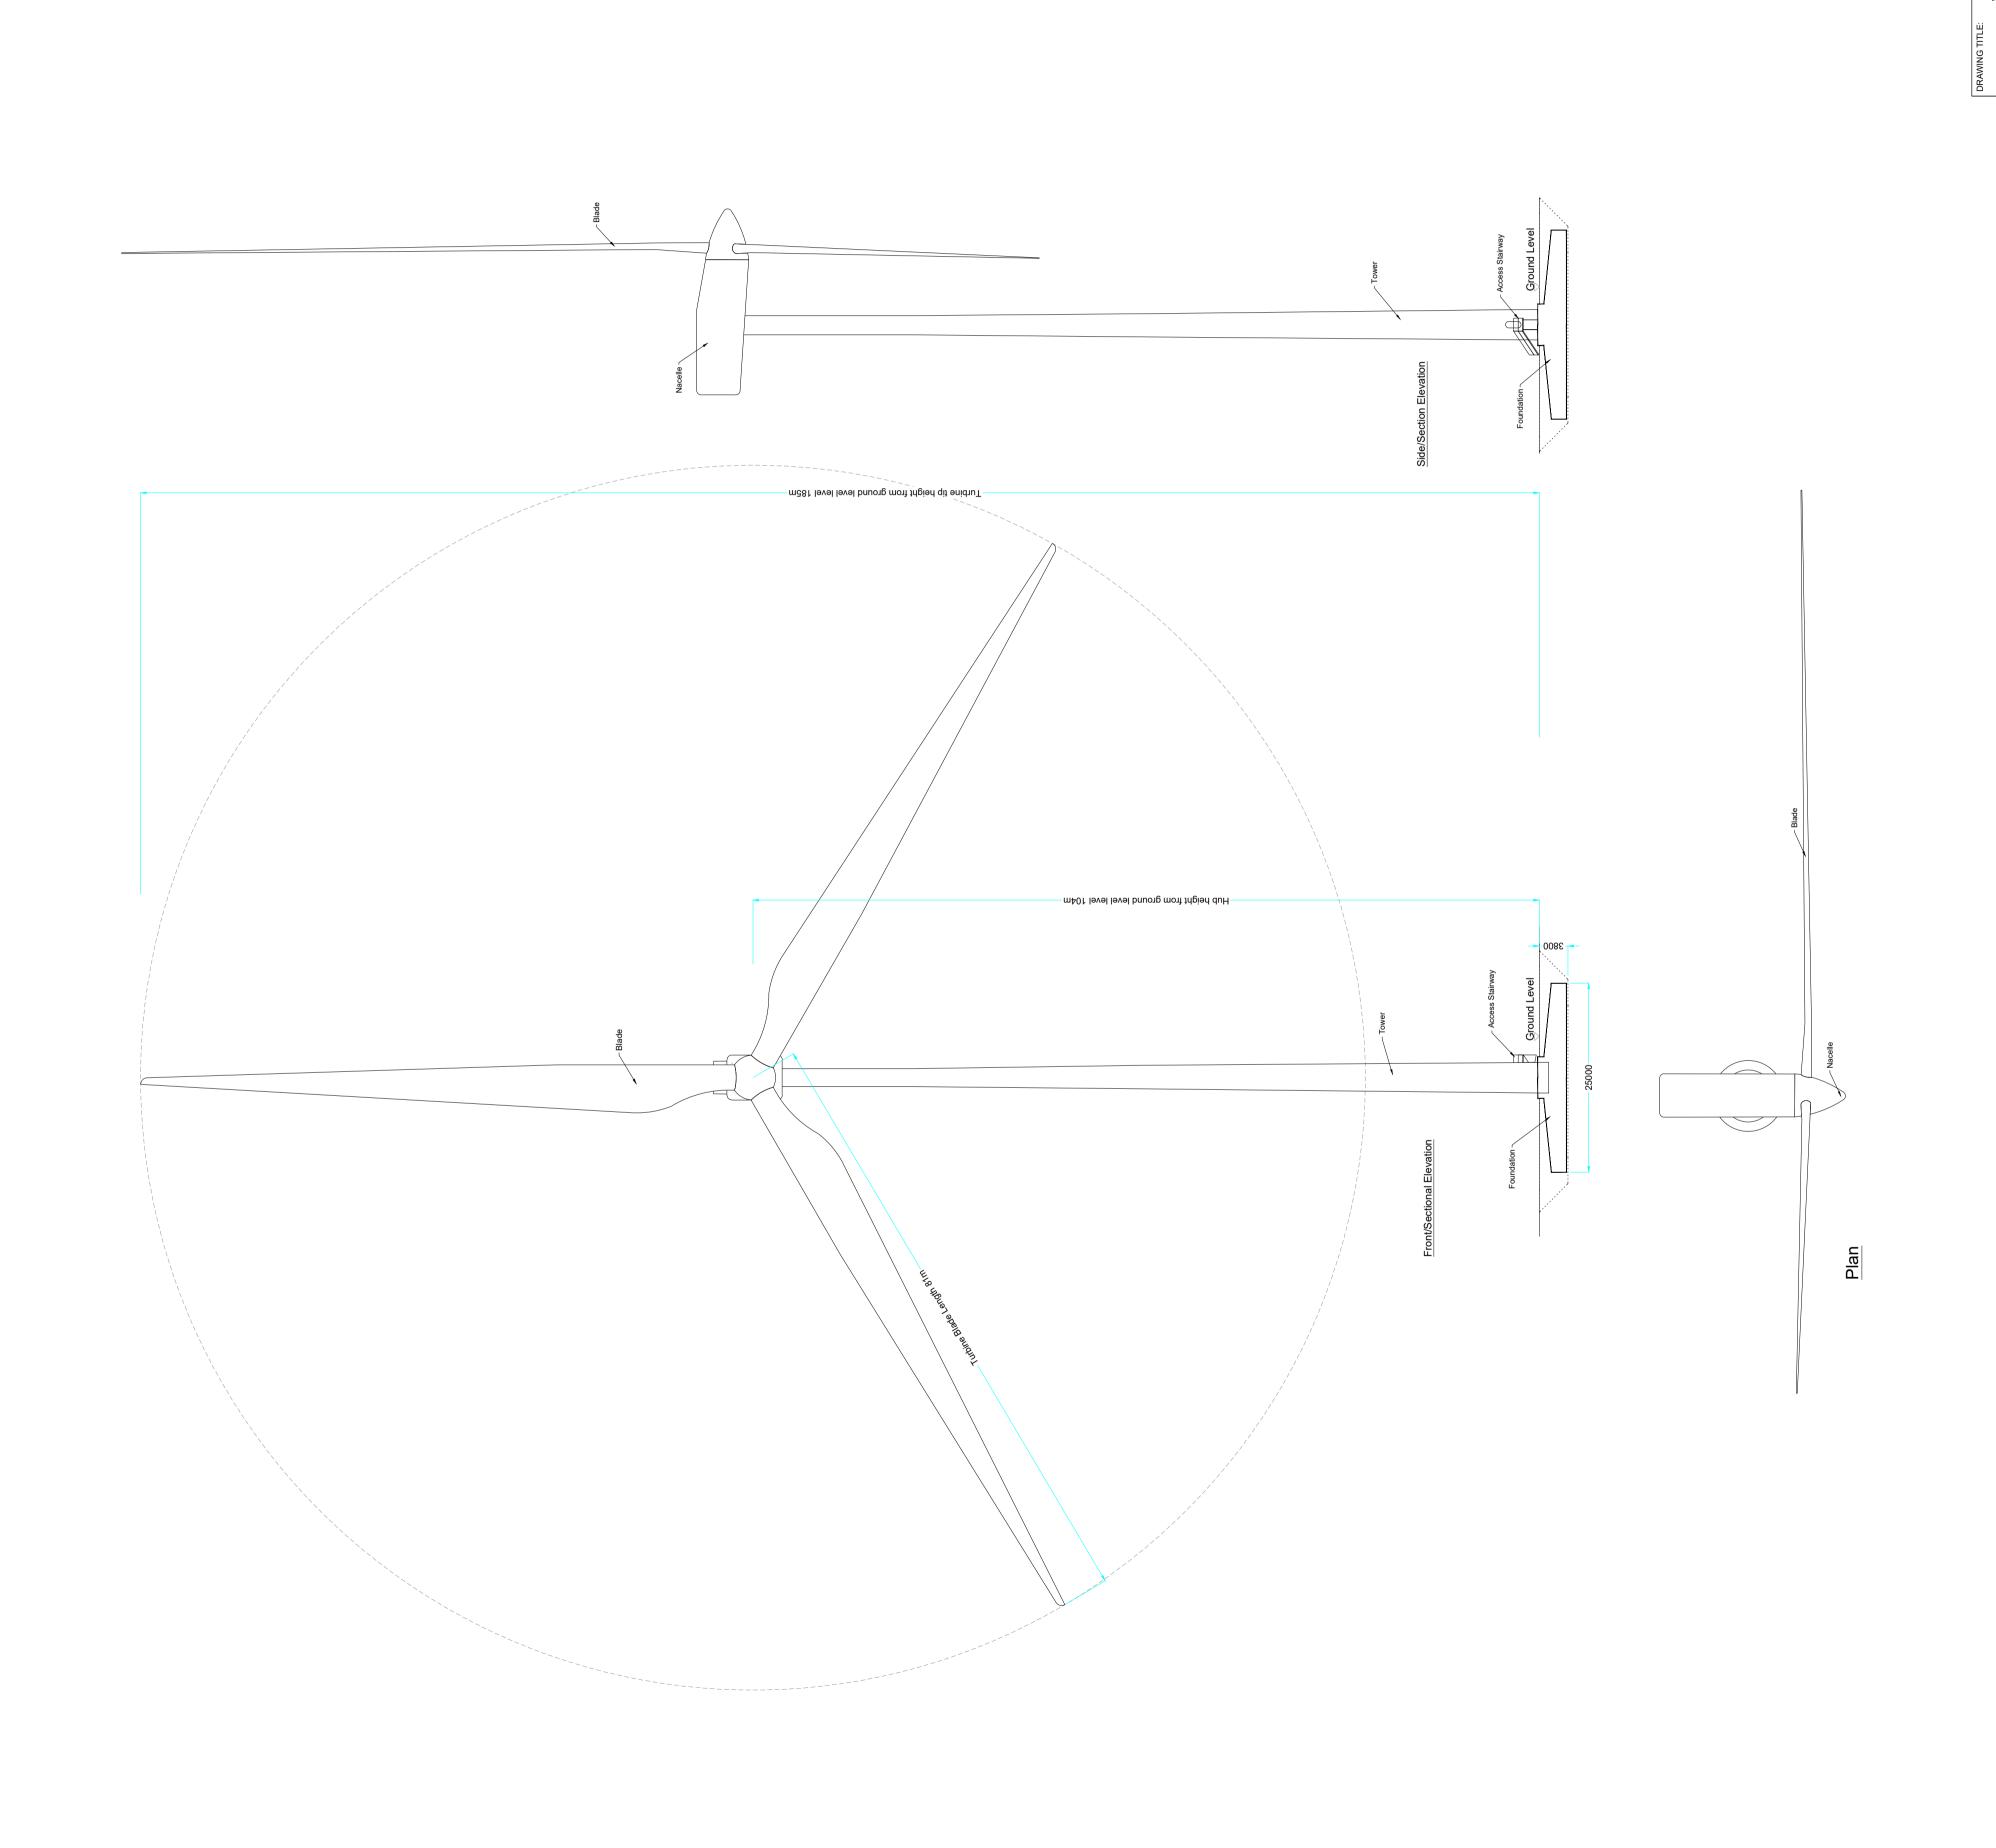

Mind Turbine
Elevations & Plan
Elevations & Plan
Elevations & Plan
ECTTUTE:

MING BY:

Joseph O Brien

Joseph O Brien

201050

ATTUTE:


LISO0 @A1

Development, Co. Westmeath
CHECKED BY:
Ellen Costello
DRAWING NO.:
201050 - 24

201050

Drawing Notes

- Widening can occur to either side of existing roads dependent on site conditions.
- Depths of road fill to vary dependent on site conditions.

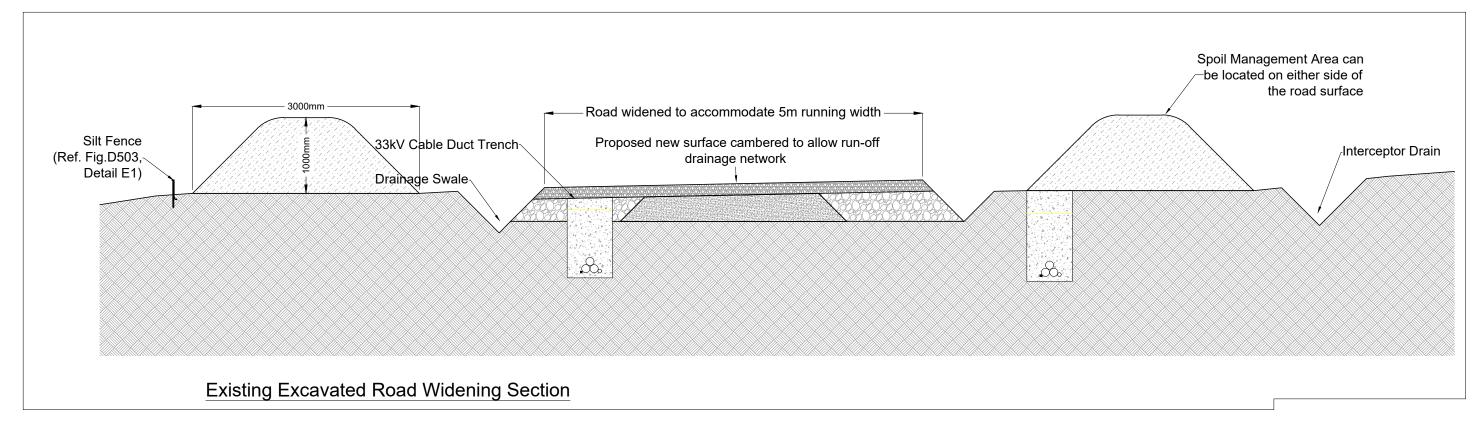

The cabling may be placed on either side of the roads, on both sides of the road or within the road. The exact configuration of the underground cabling will be set by the requirements of the electrical designers at detailed design stage.



Development, Co. Westmeath

DRAWING BY:

Joseph O Brien

CHECKED BY:


Ellen Cost

| Joseph O Bi | rien Ellen Costello |
|------------------------|-----------------------------|
| PROJECT No.: 201050 | DRAWING No.: 201050 - 25 |
| 1:50@A3 | 02.03.2023 |
| | • |



Drawing Notes

- Widening can occur to either side of existing roads dependent on site conditions.
- . Depths of road fill to vary dependent on site conditions.

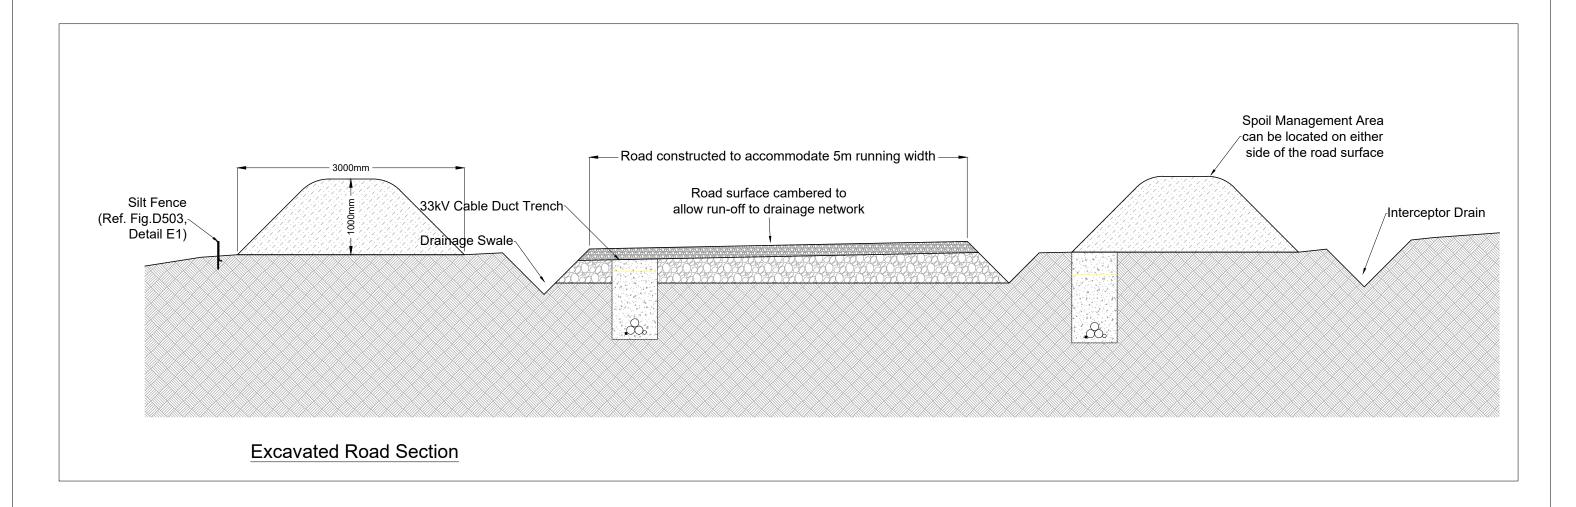


The cabling may be placed on either side of the roads, on both sides of the road or within the road. The exact configuration of the underground cabling will be set by the requirements of the electrical designers at detailed design stage.

Proposed New Excavated Road Section

Umma More Renewable Energy
Development, Co. Westmeath

| Joseph O Brien | Ellen Costello |
|------------------------|----------------|
| PROJECT No.: 201050 | 201050 - 26 |
| 1:50@A3 | 02.03.2023 |



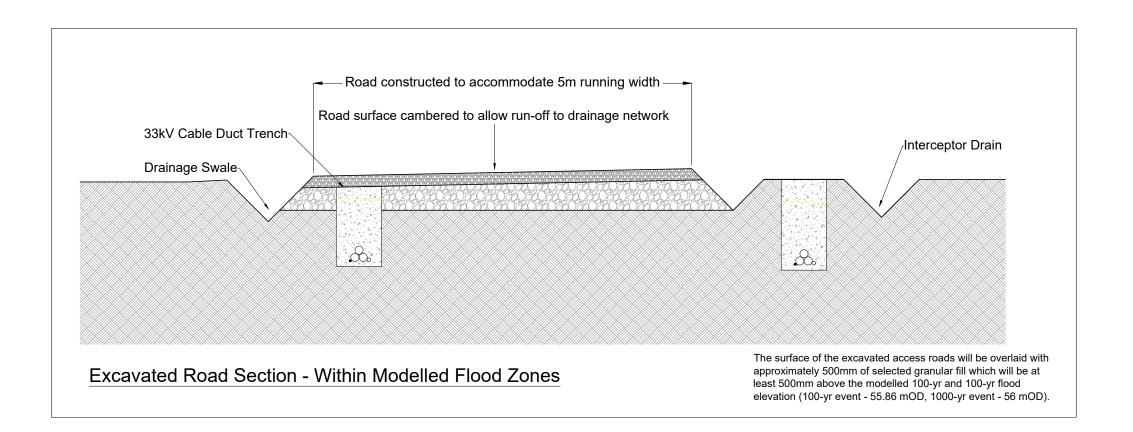

The cabling may be placed on either side of the roads, on both sides of the road or within the road. The exact configuration of the underground cabling will be set by the requirements of the electrical designers at detailed design stage.

Excavated road section in Site-Specific Flood Modelled Zones

Drawing Notes

on site conditions.


Widening can occur to either side of existing roads dependent on site conditions.


Depths of road fill to vary dependent


Umma More Renewable Energy
Development, Co. Westmeath

| Joseph O Brien | Ellen Costello |
|------------------------|-----------------------------|
| PROJECT No.: 201050 | DRAWING No.: 201050 - 27 |
| 1:50@A3 | 02.03.2023 |



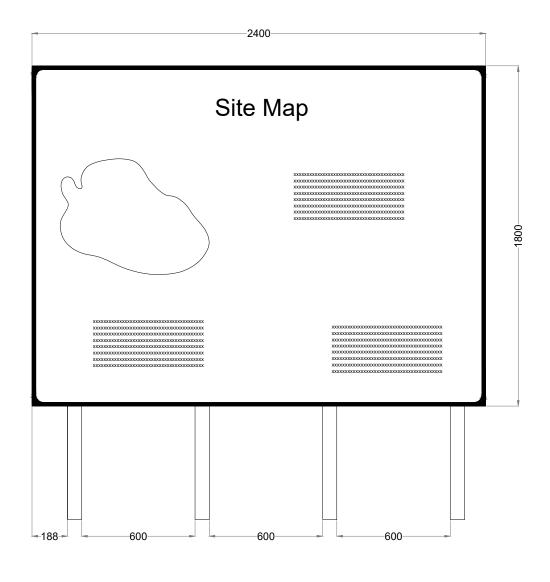

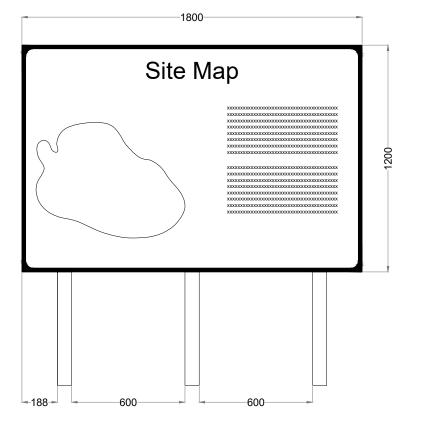

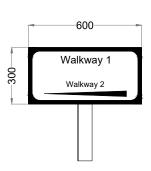


Signage Type C - Way Point Direction Signage


Signage Type A - Waypoint Map Signage

Signage Type B - Entry Point Signage




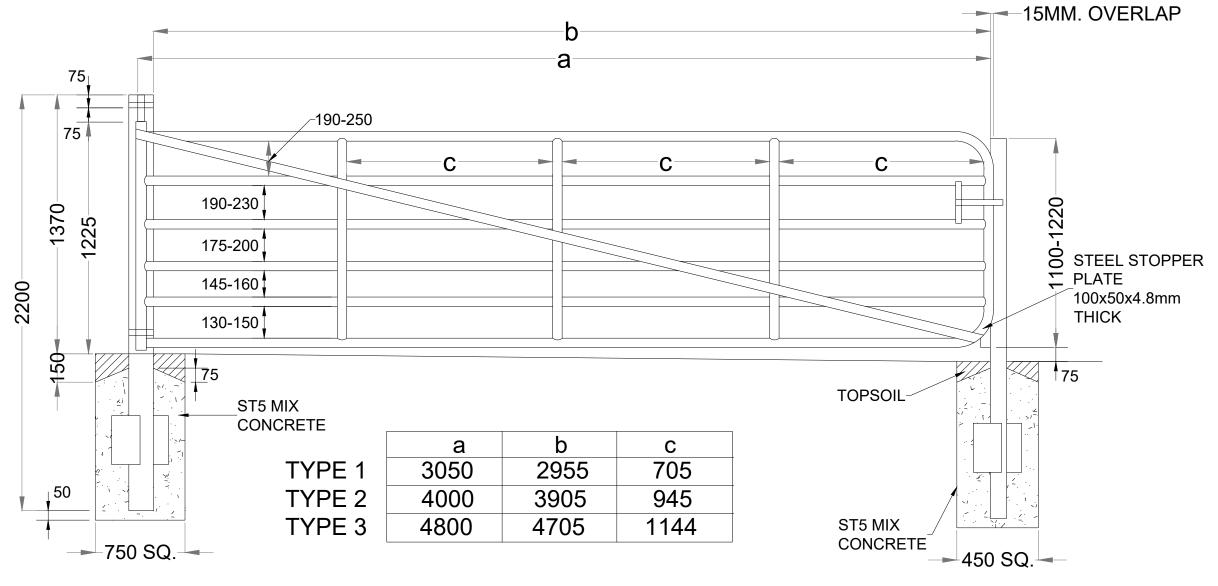




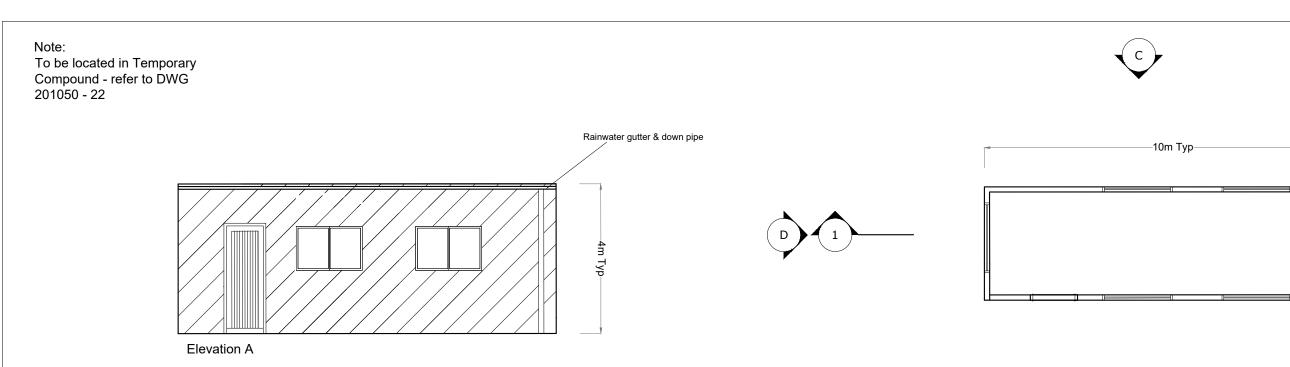




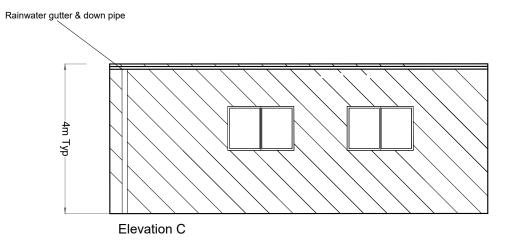


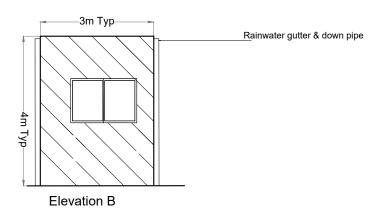

Staff WC

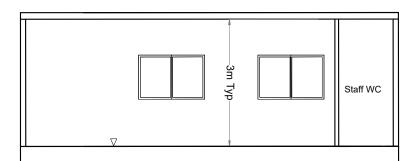

Section 1-1

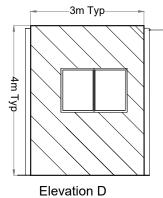


Site Office & Staff Facilities Detail


Rainwater gutter & down pipe

PROJECT Unima More Renewable Energy
Development, Co. Westmeath

| Joseph O Brien | Ellen Costello |
|------------------------|-----------------------------|
| PROJECT No.: 201050 | DRAWING No.: 201050 - 30 |
| 1:100 @ A3 | 02.03.2023 |



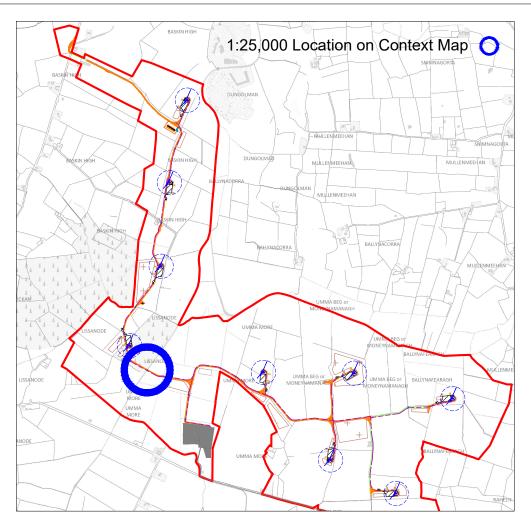

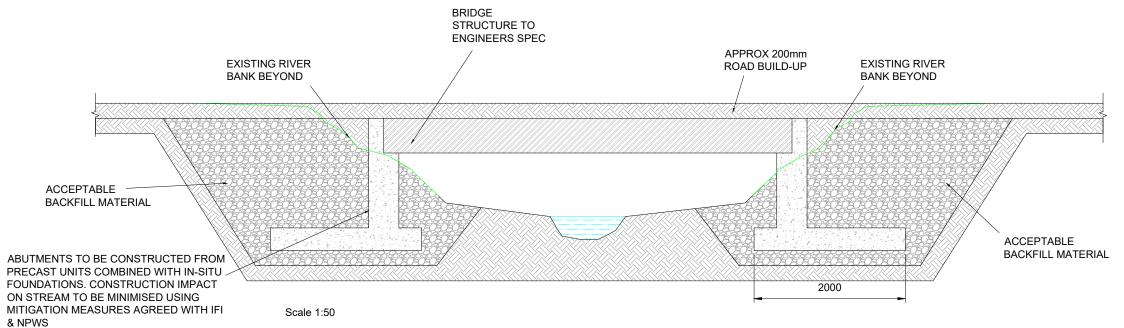




Clear Span Bridge Crossing

Umma More Renewable Energy Development, Co. Westmeath

| Joseph O Brien | Ellen Costello |
|-----------------------------|----------------|
| PROJECT No.: 201050 | 201050 - 31 |
| As Shown @A3 | 02.03.2023 |
| OS SHEET No.: 2900, 2901, 2 | 2060 2070 |




MKO
Planning and
Environmental
Consultants
Tuam Road, Galway
Ireland, H91 WW84
- 4553 (9) 91 735611
email: info@www.mkoireland.ie
Website: www.mkoireland.ie

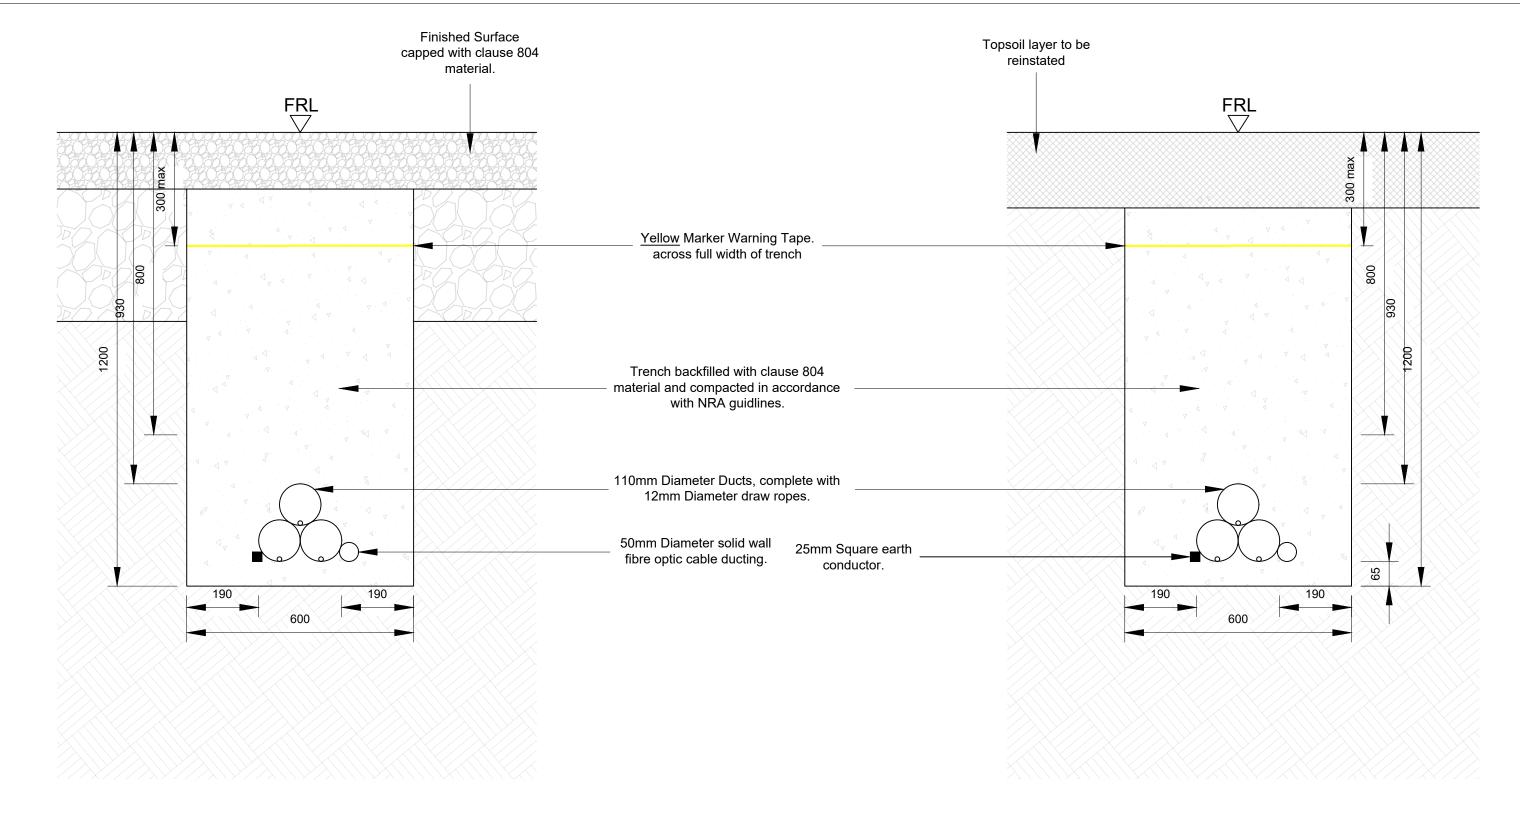



33kV Cable - On Road Trench Detail - Cross Section


33kV Cable - Off Road Trench Detail - Cross Section




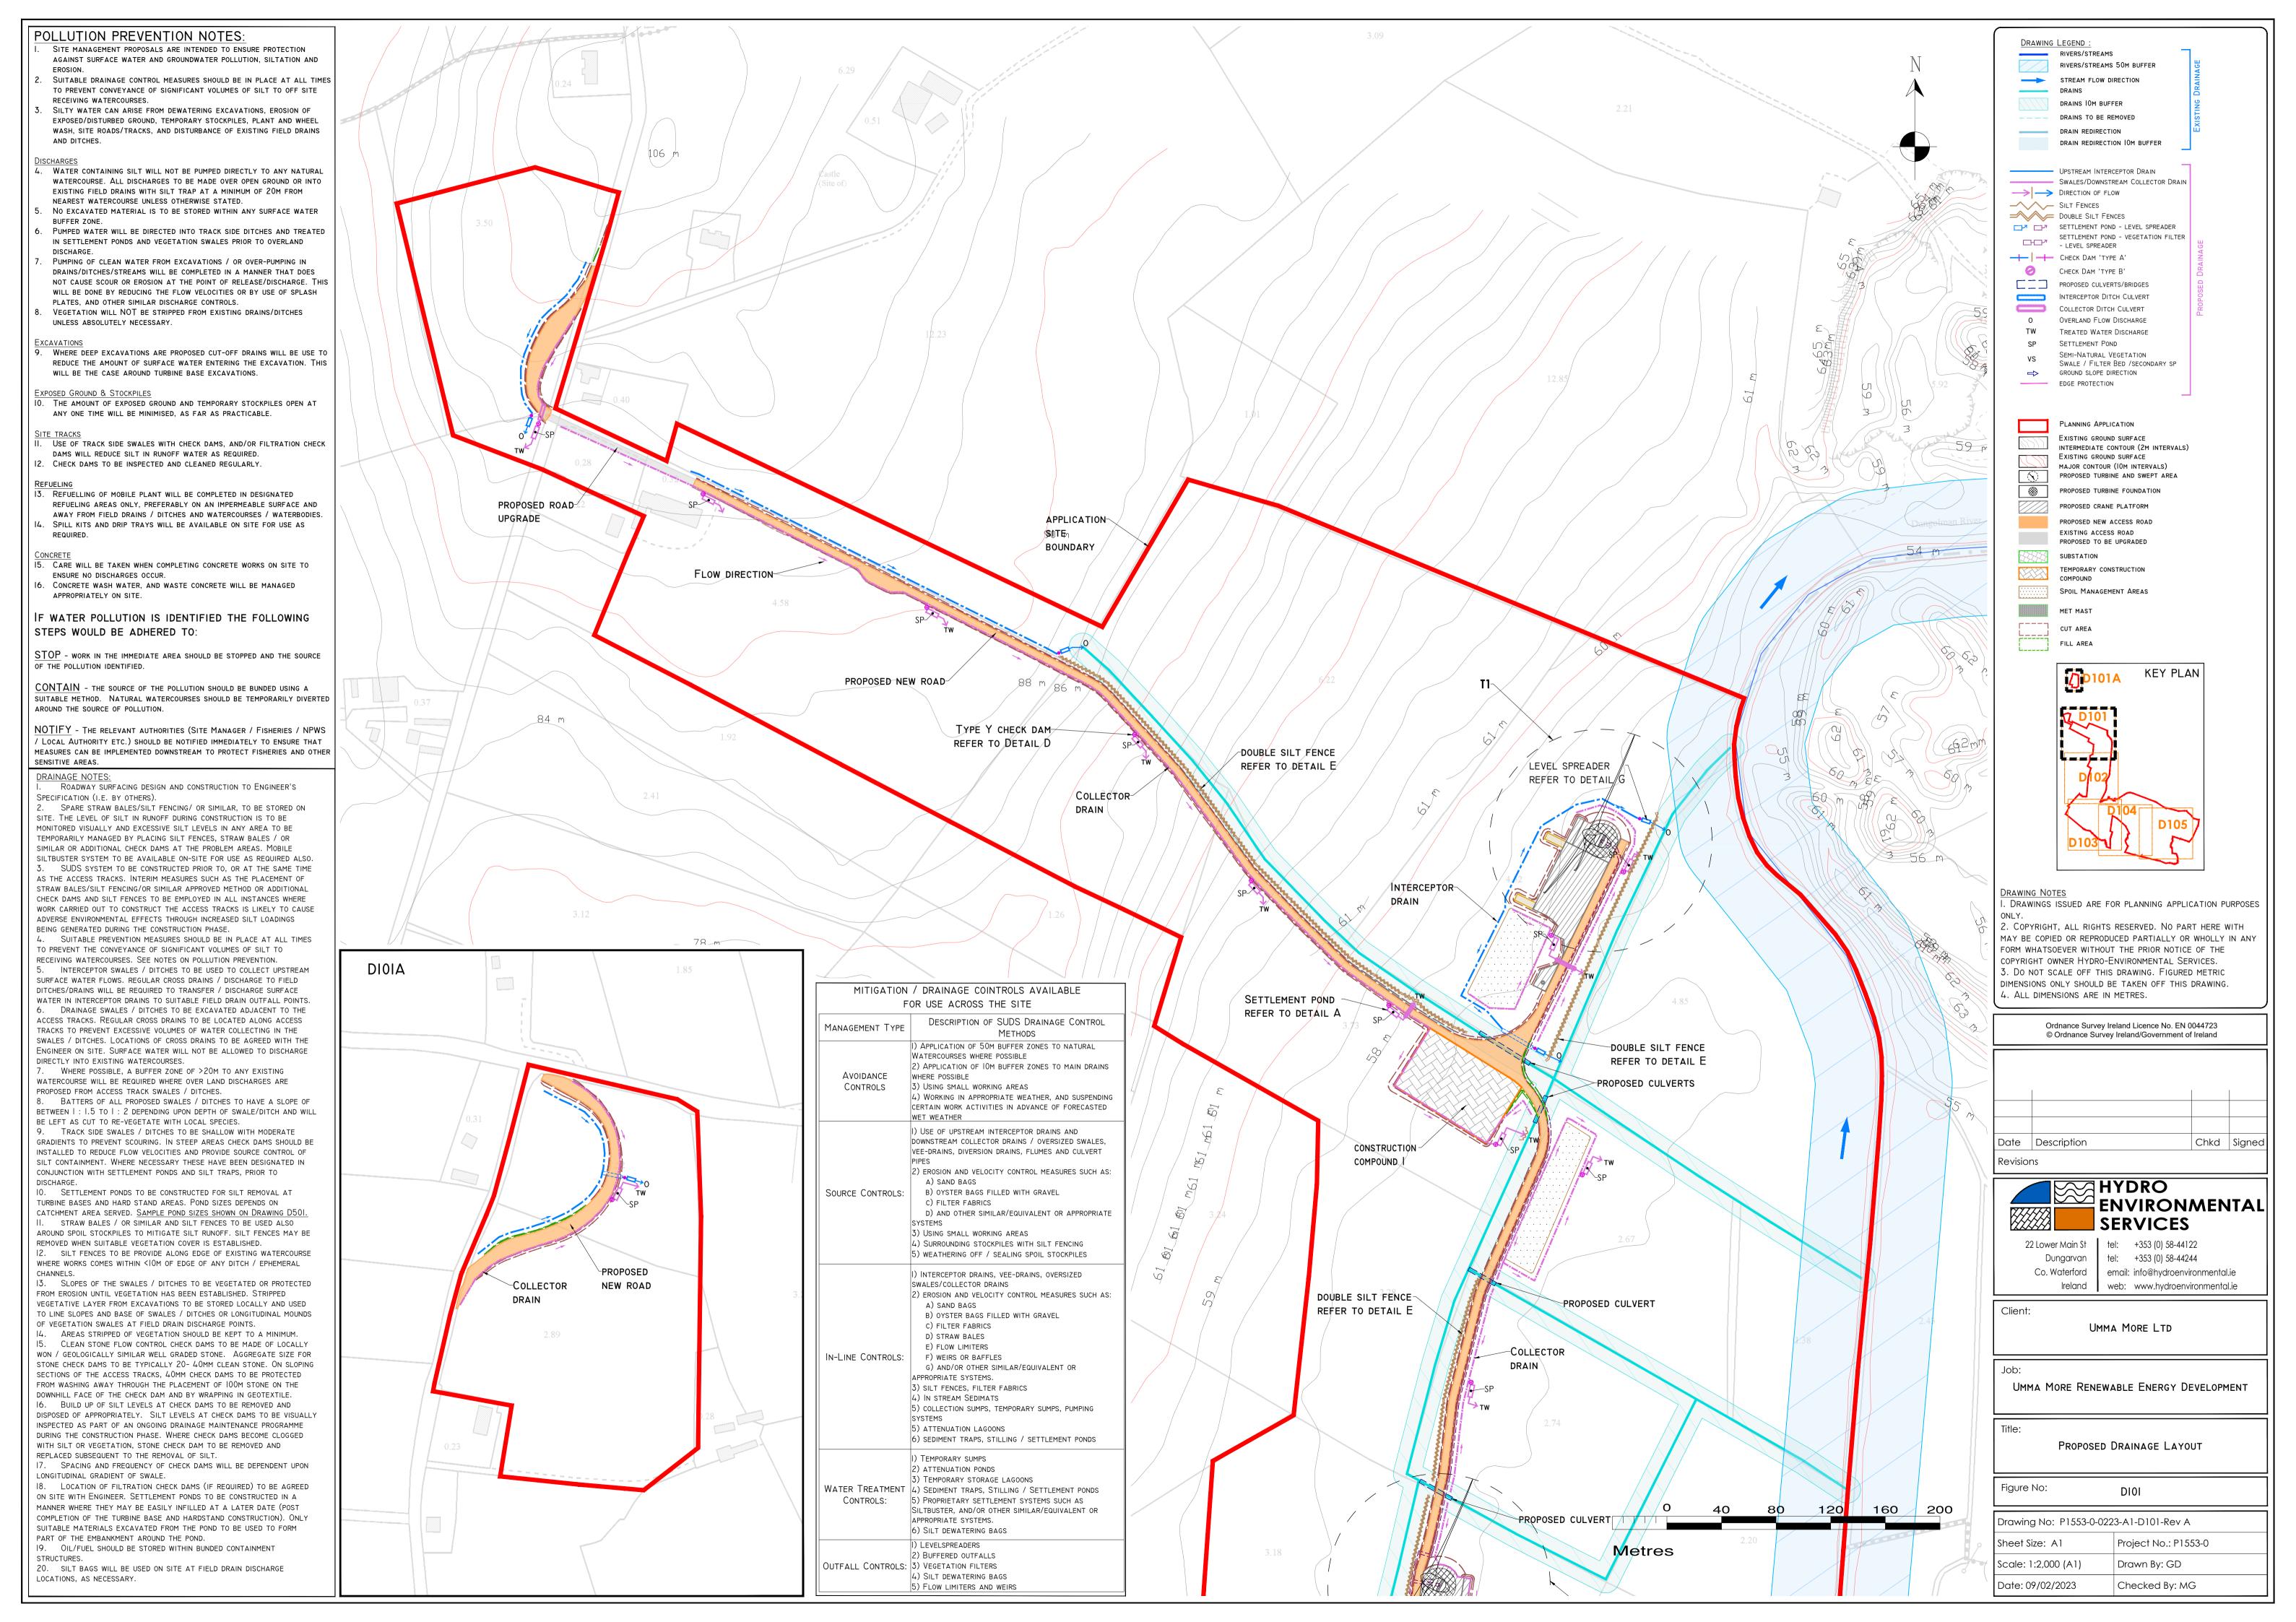

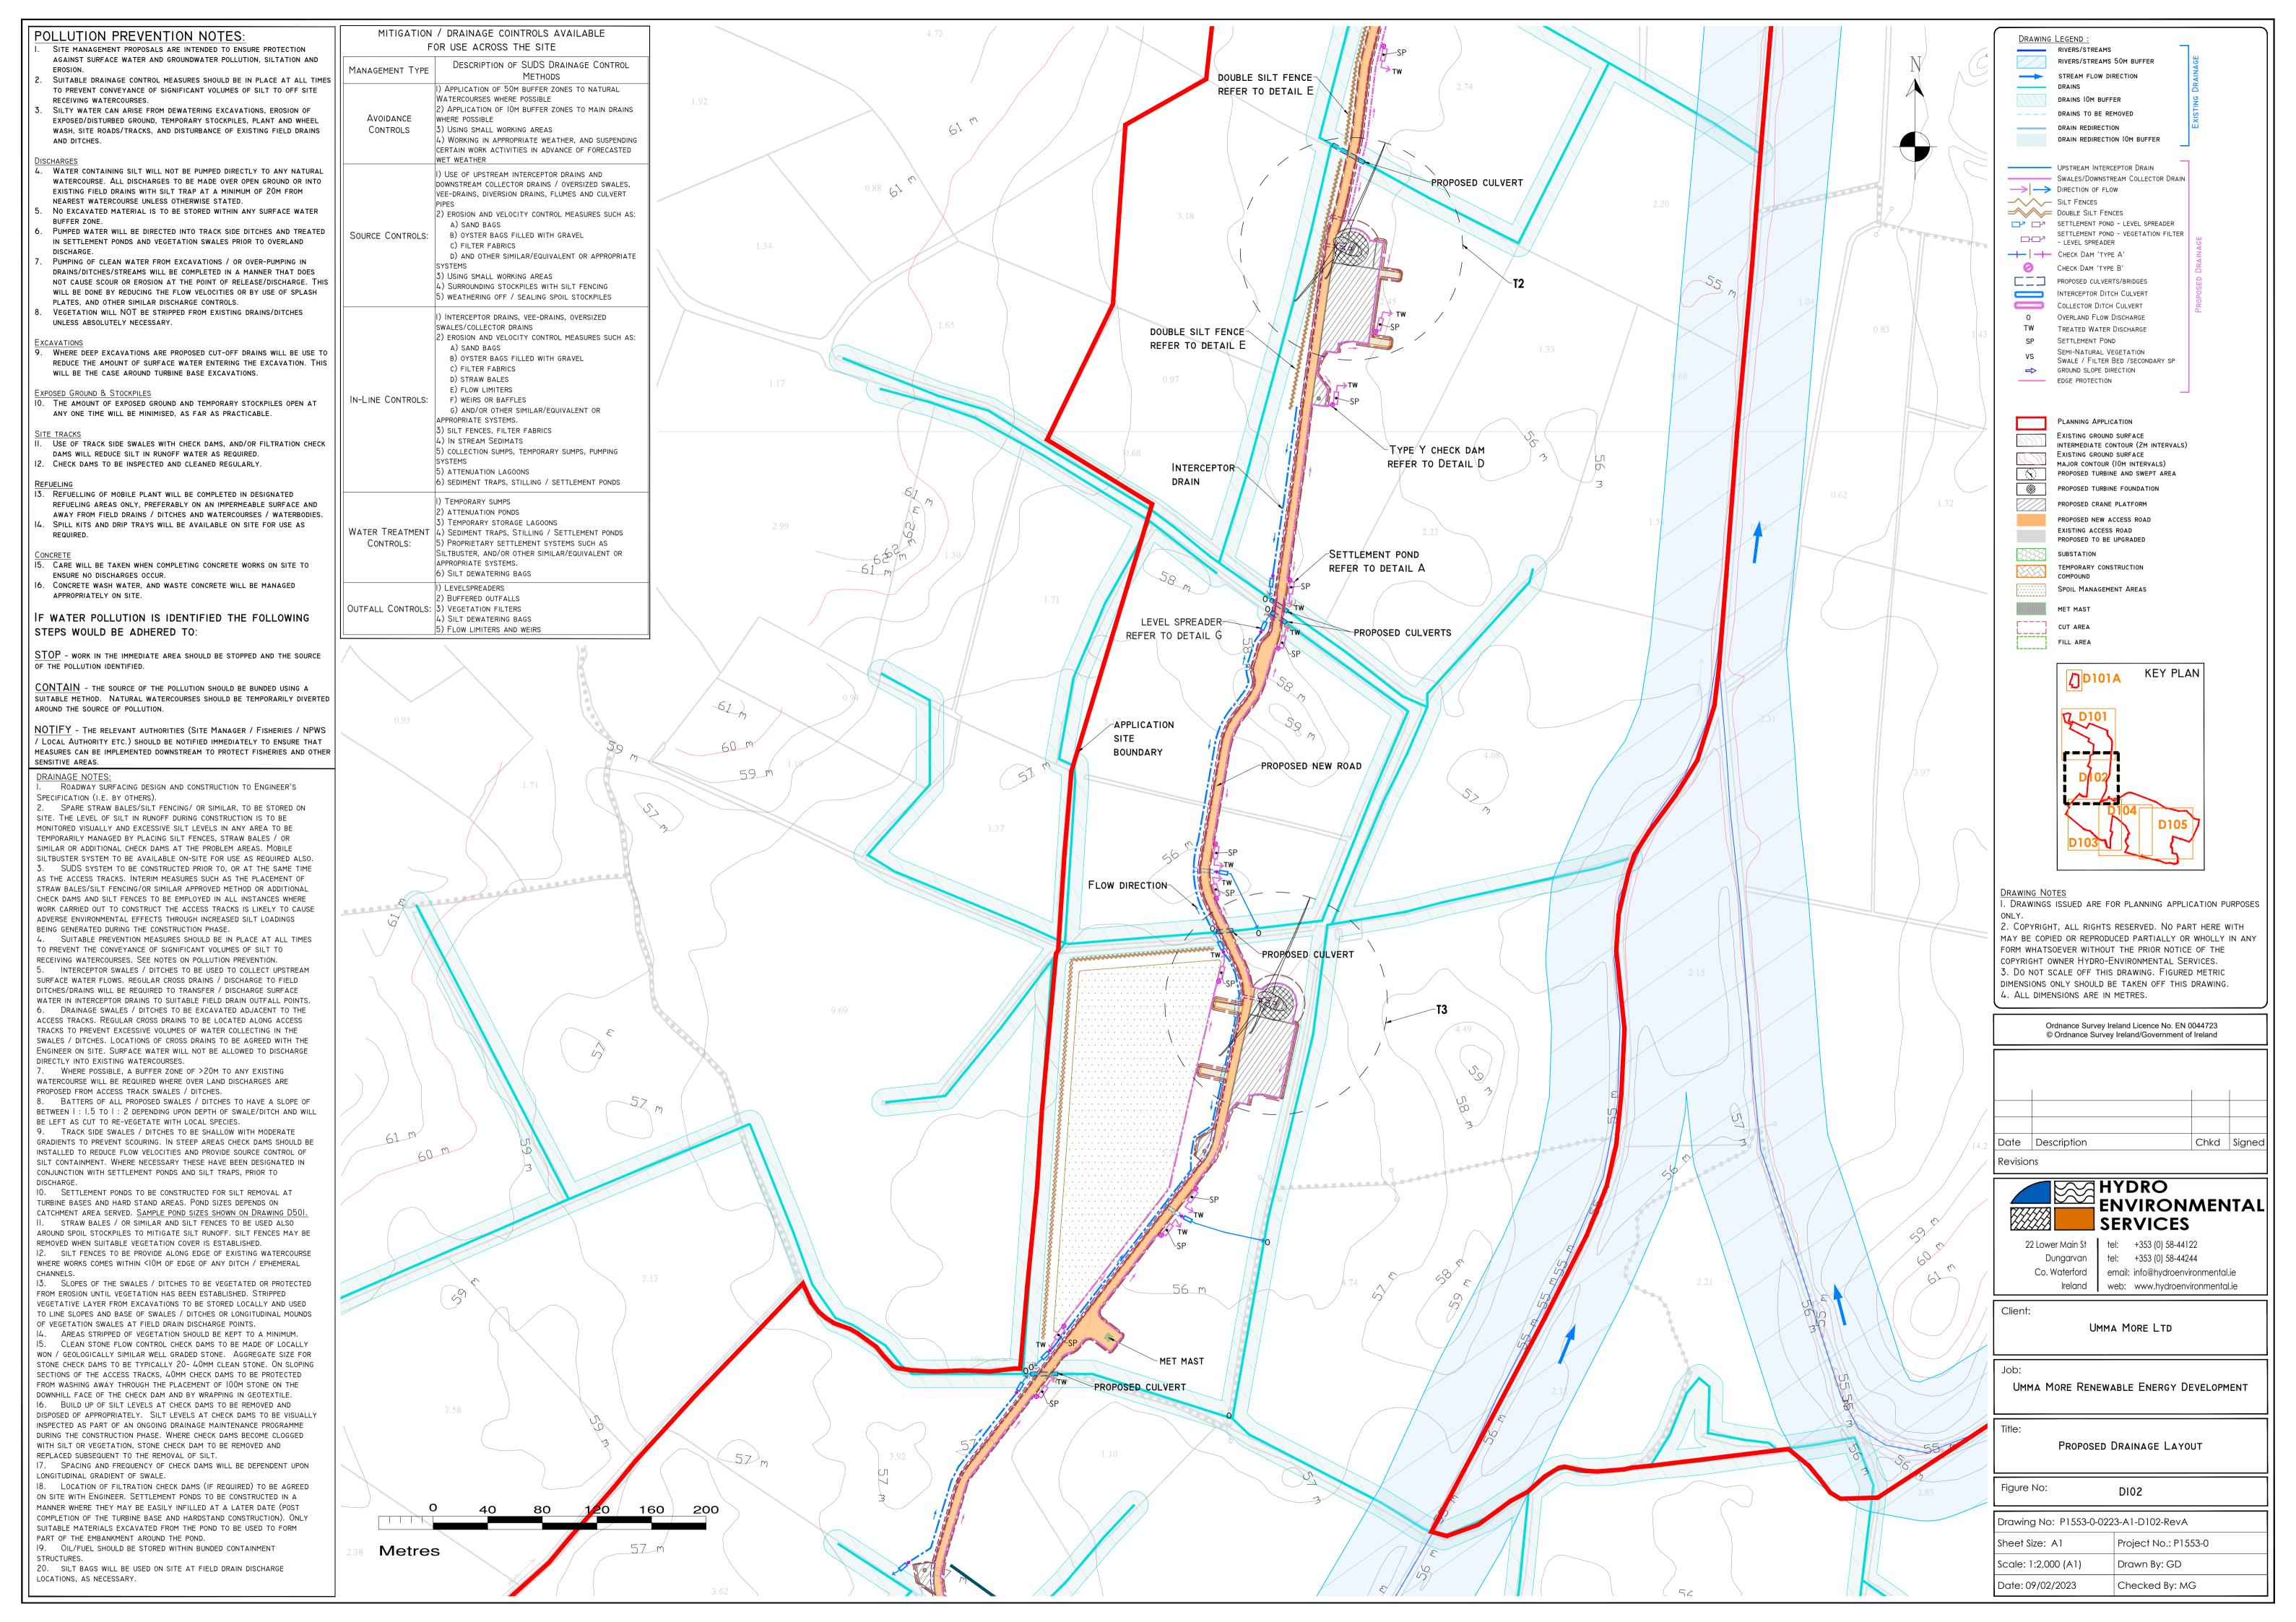

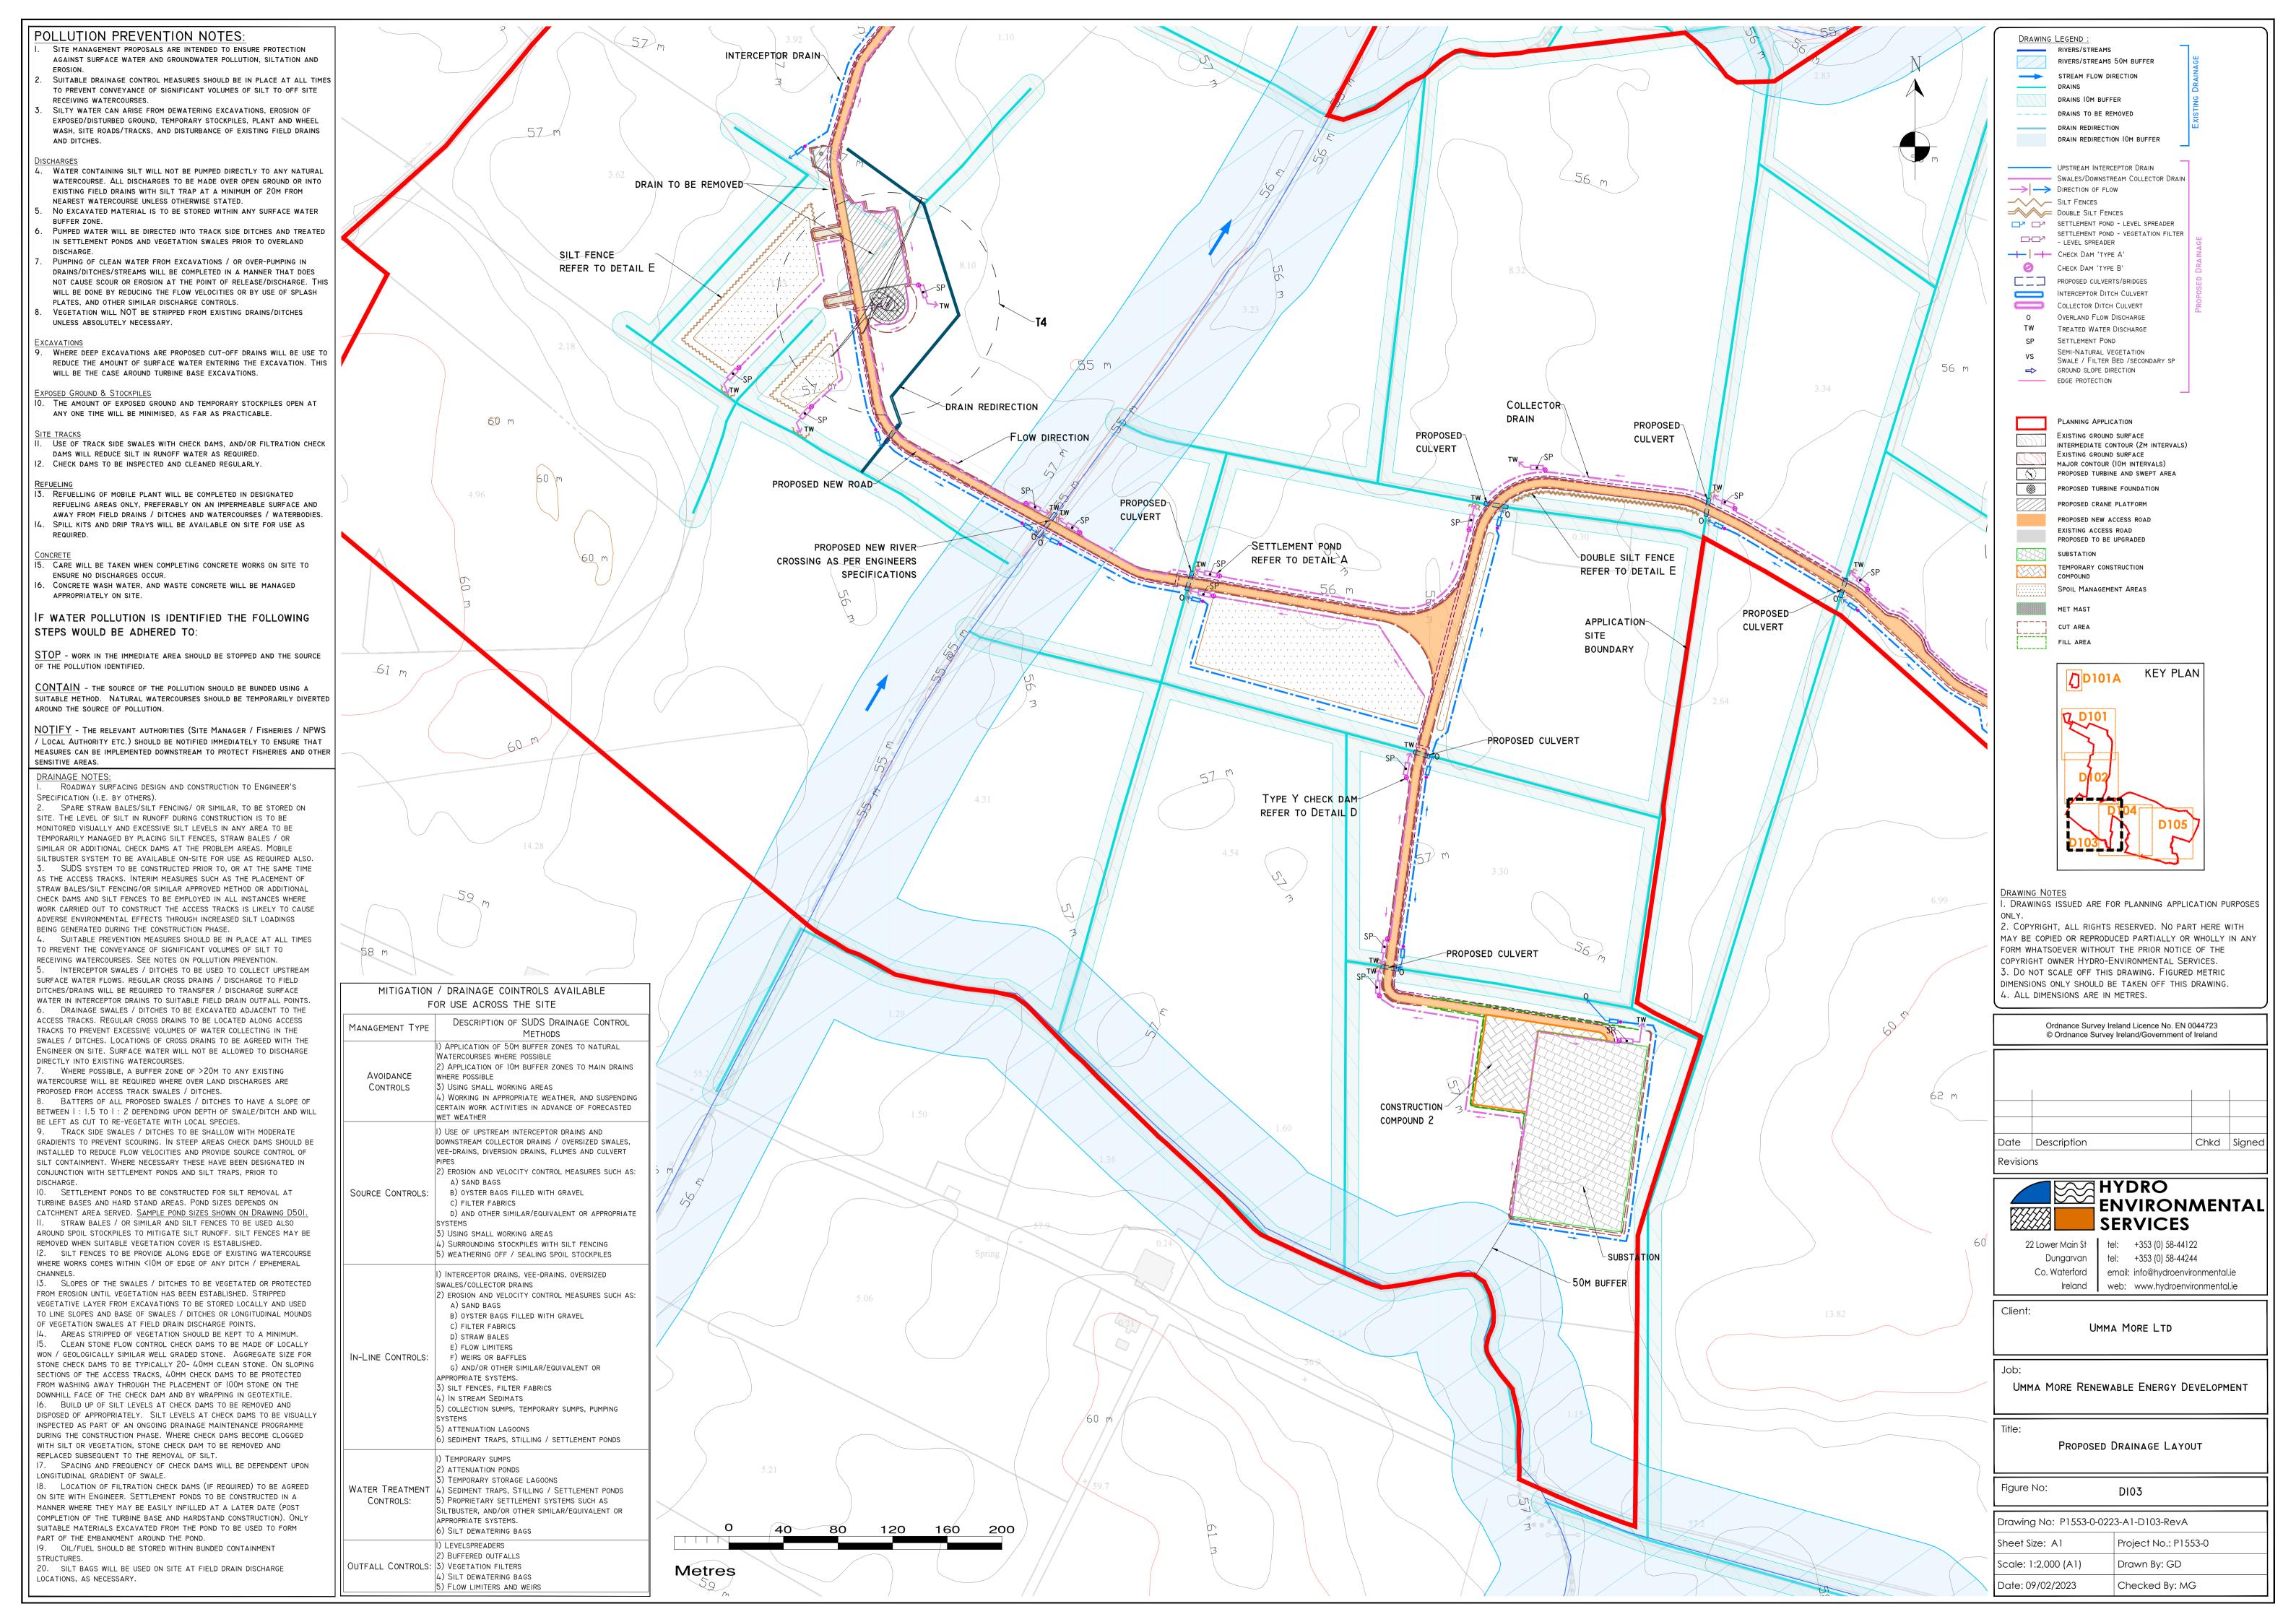

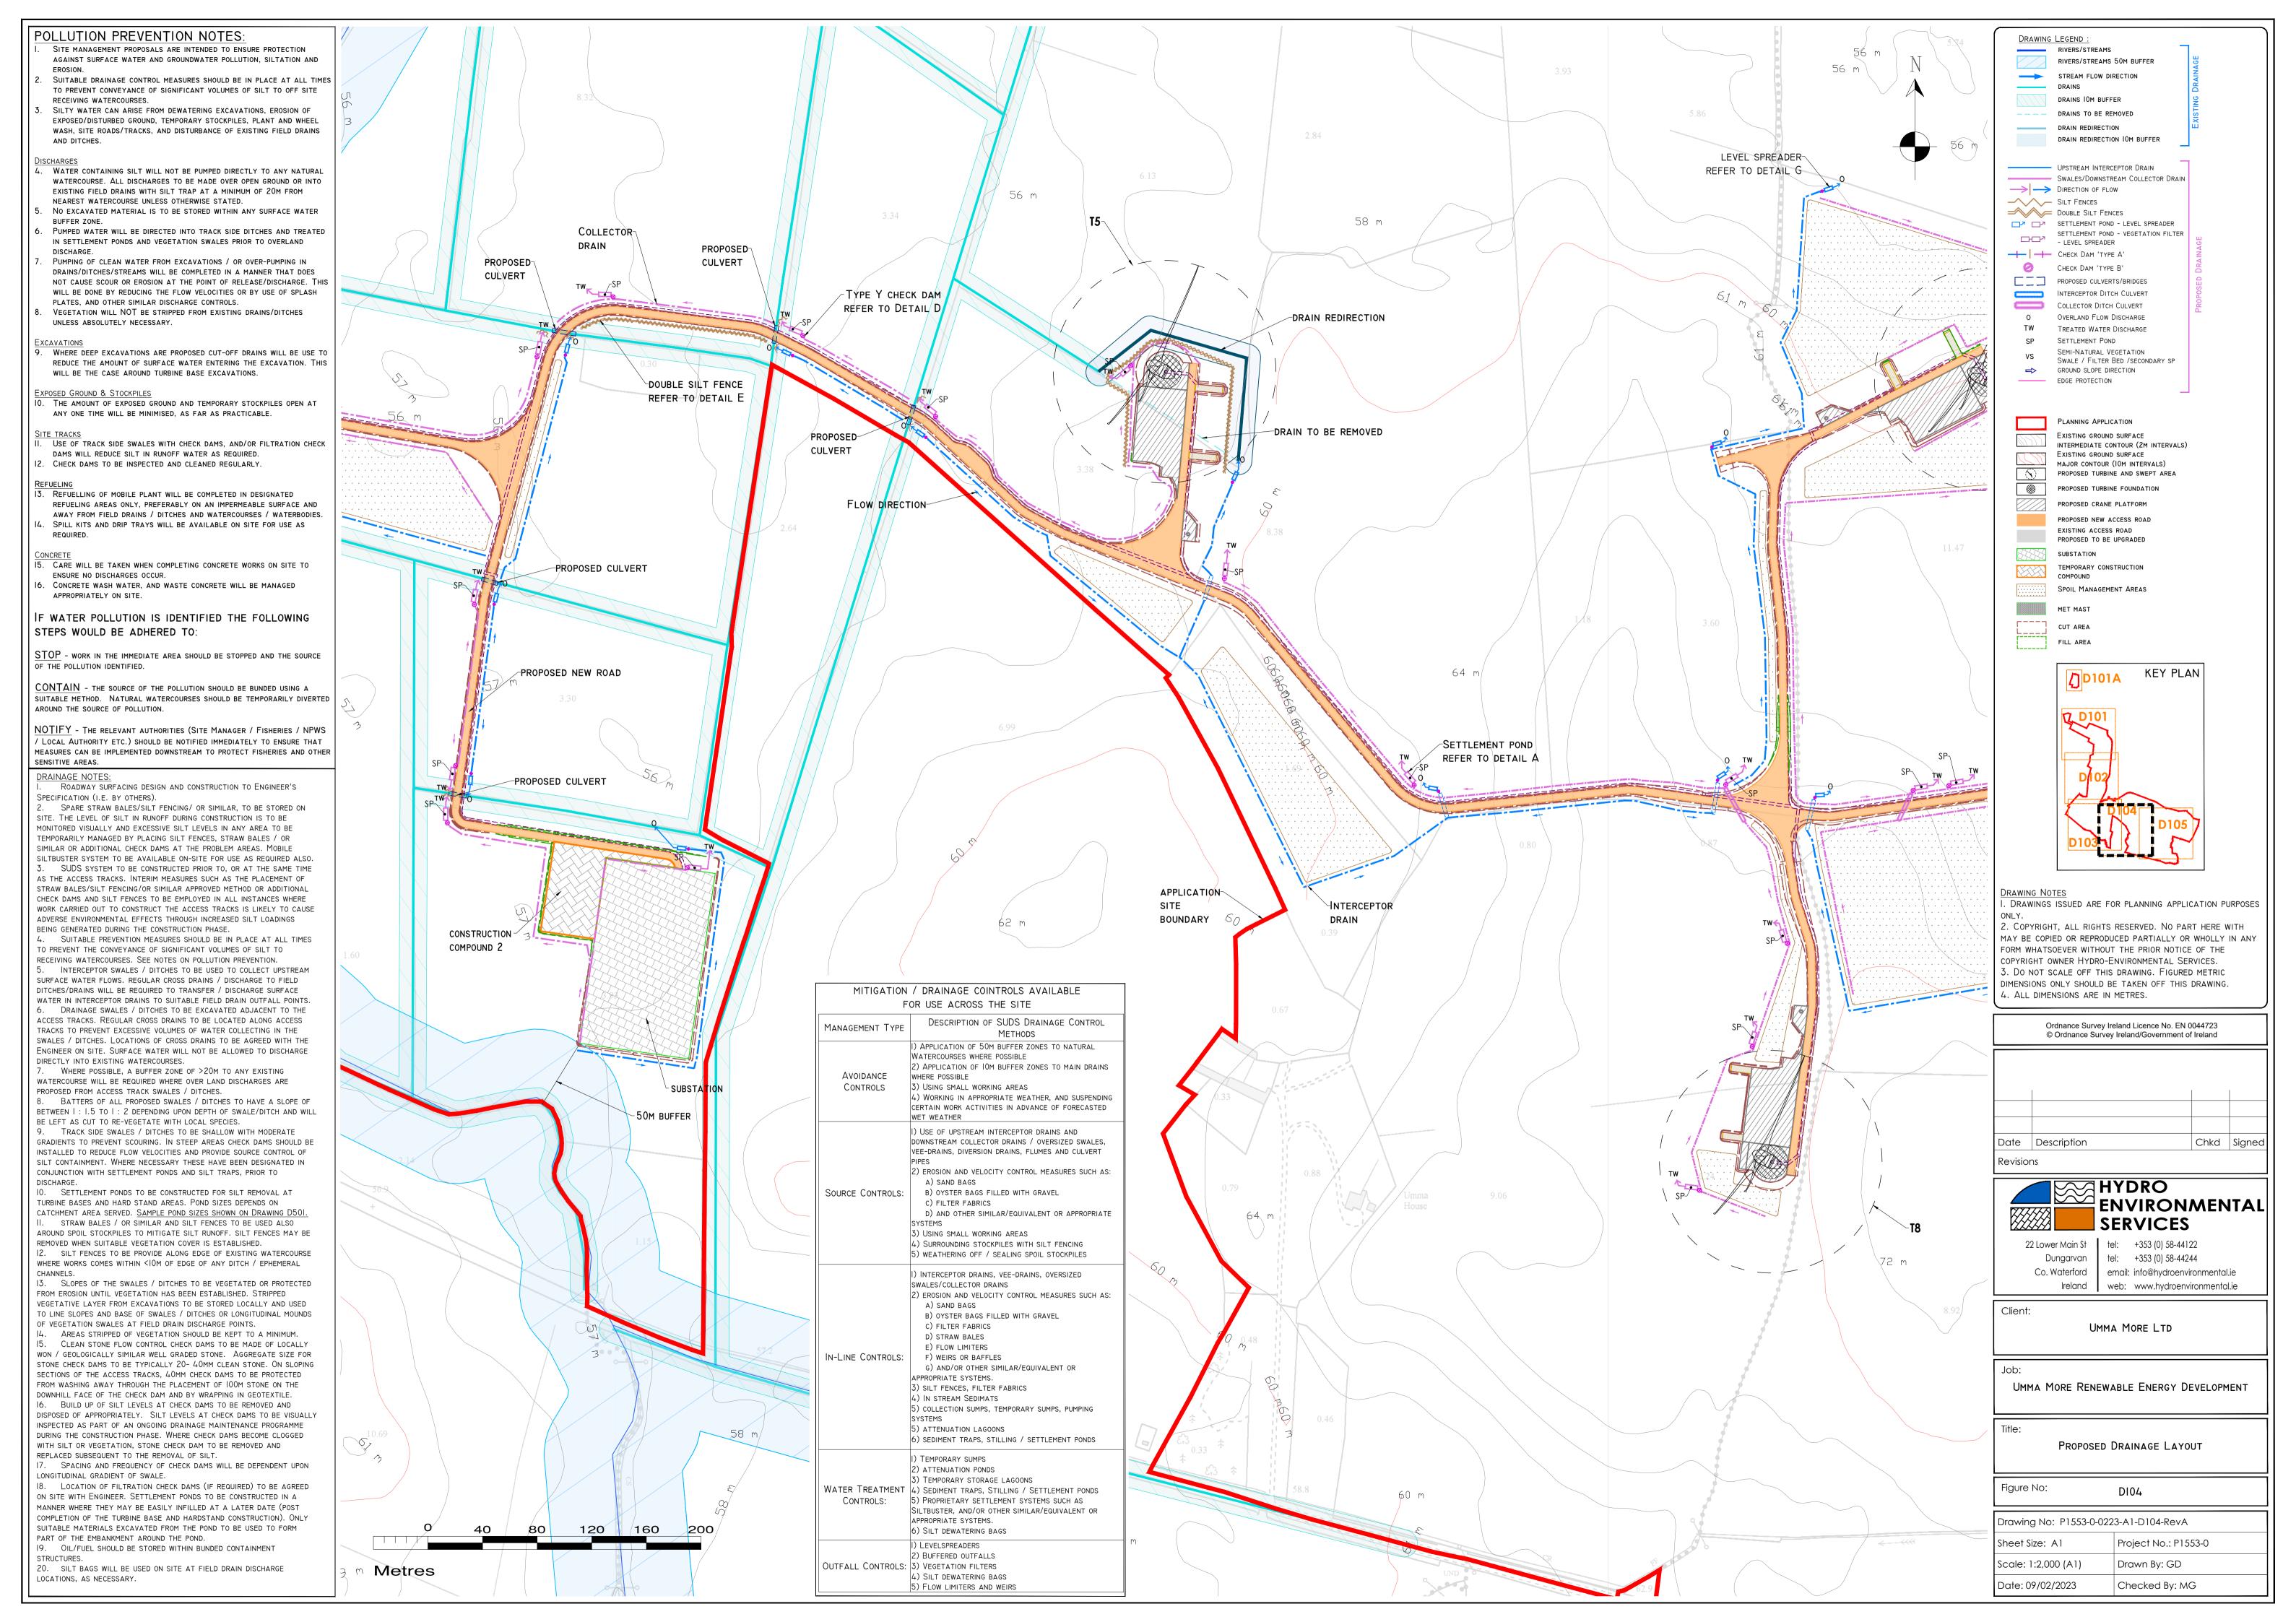

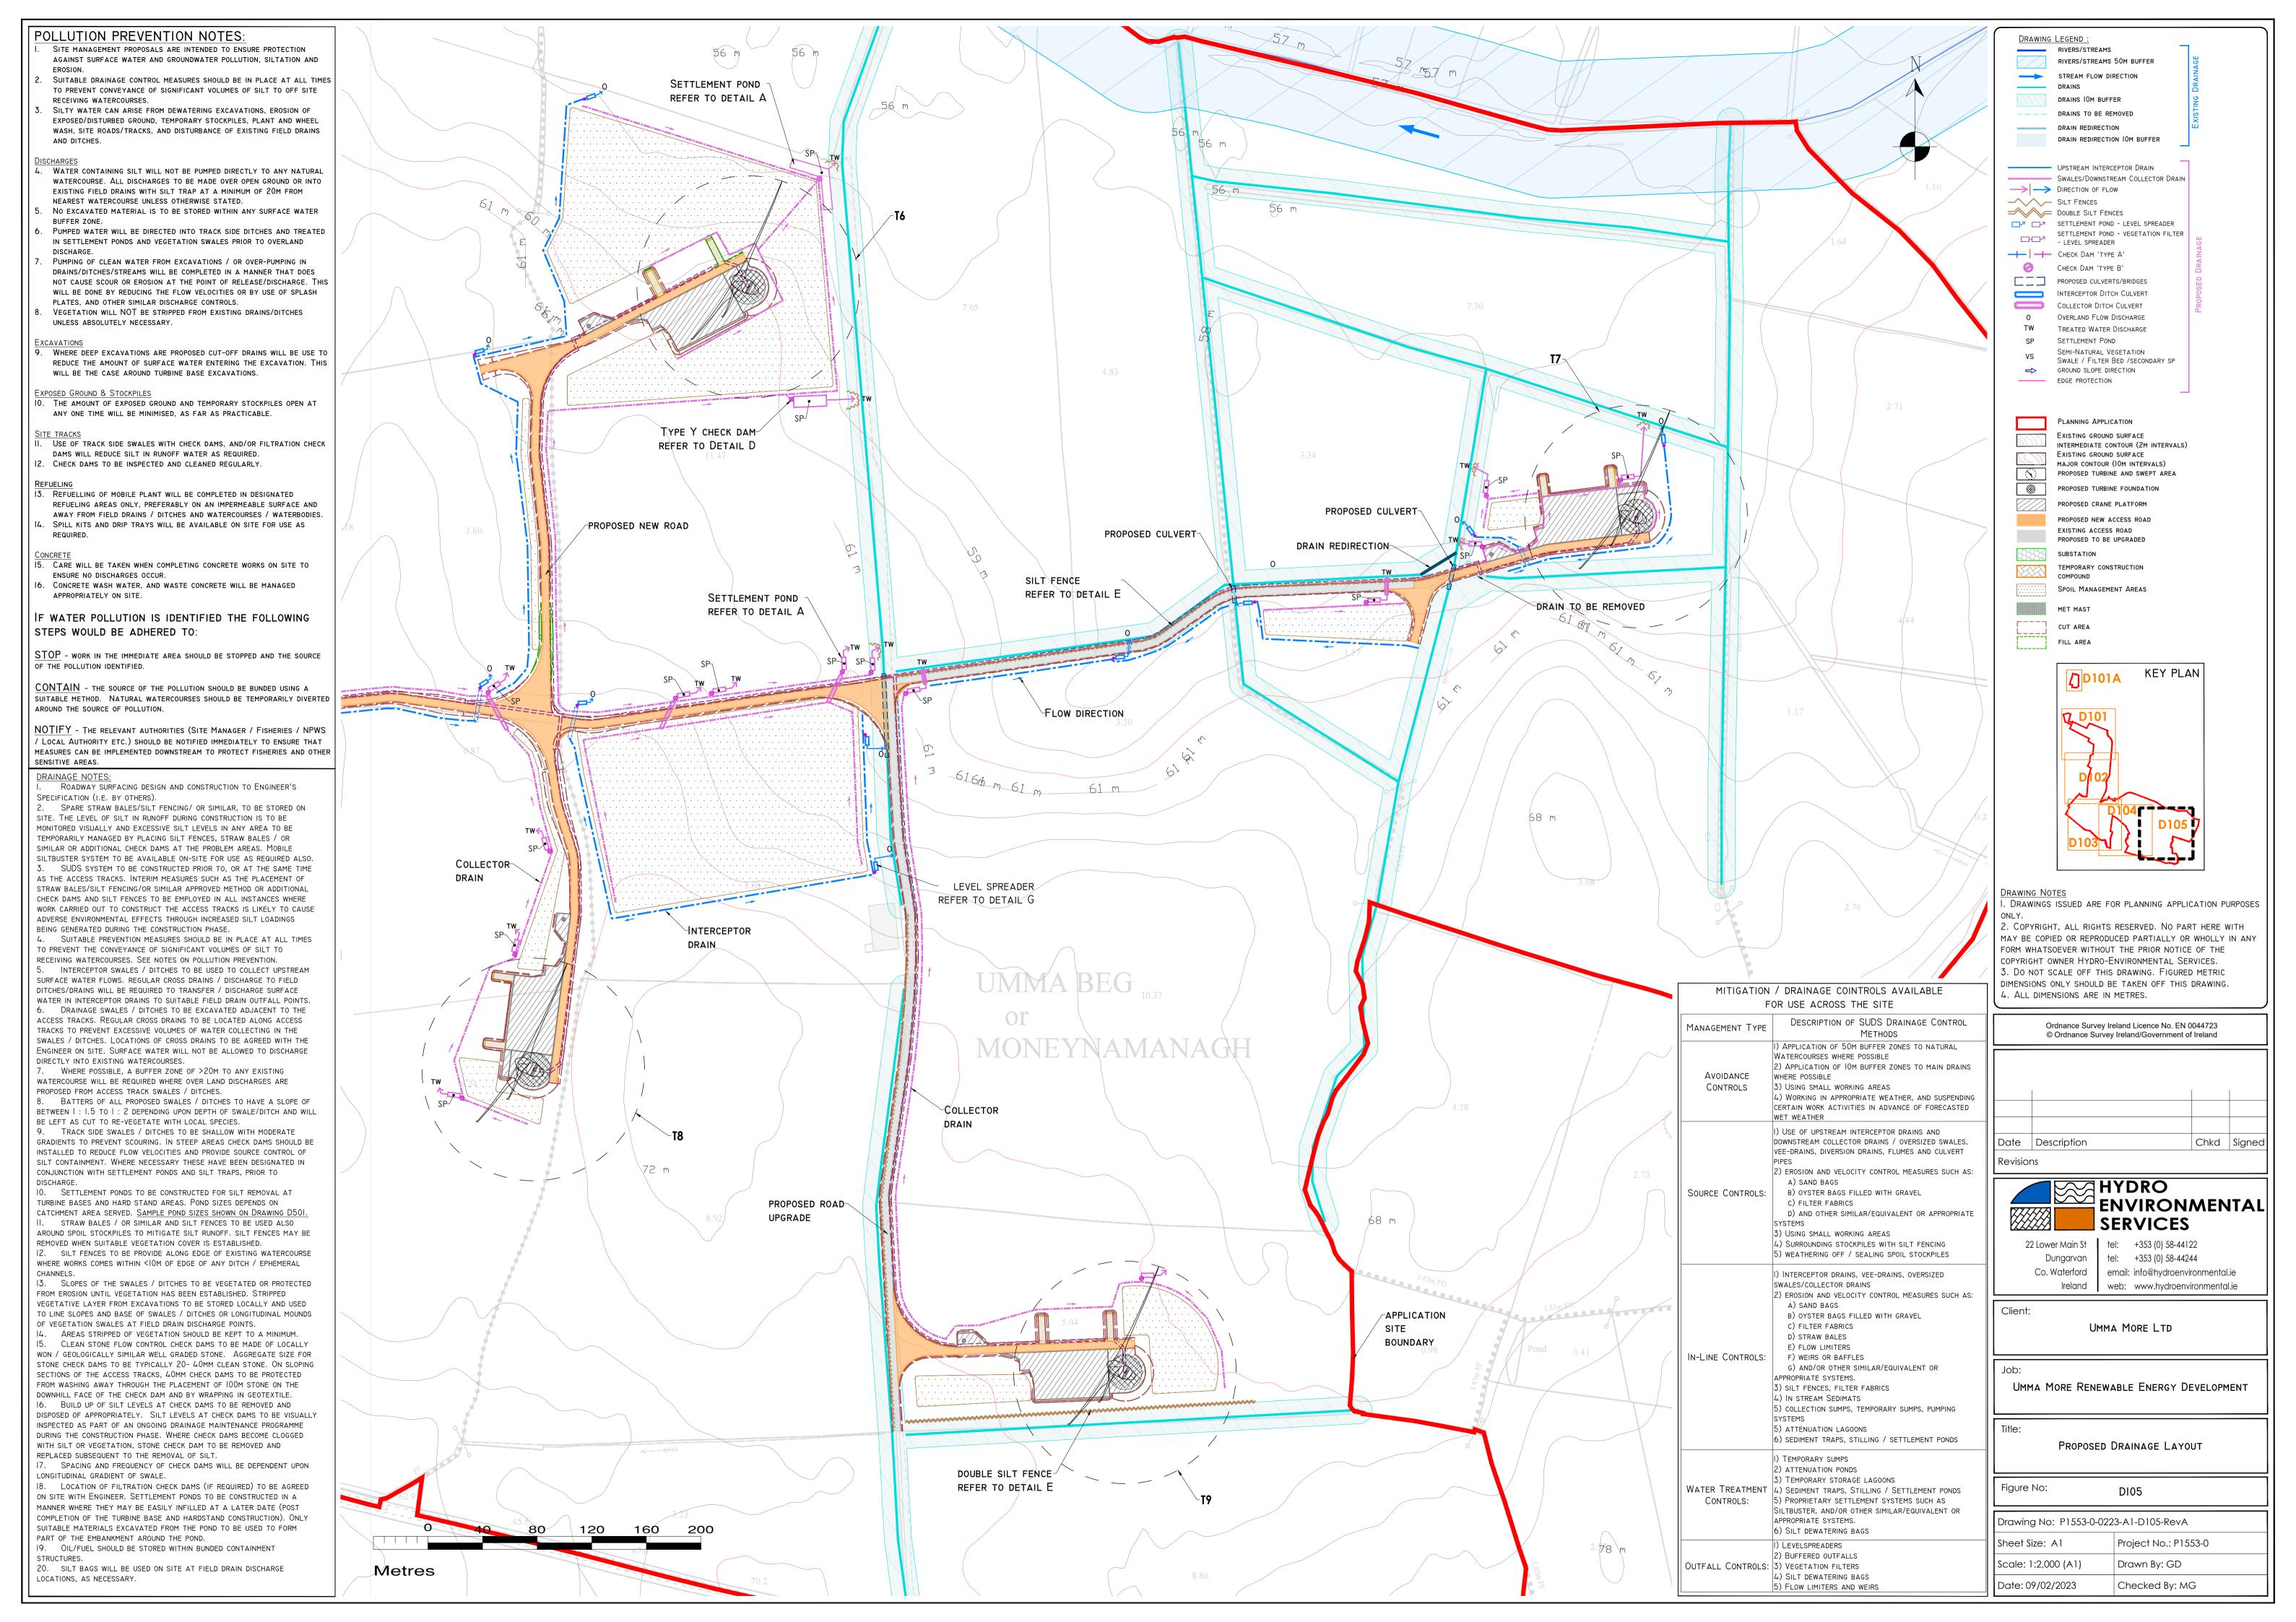

┌ GEOTEXTILE WRAP EMBEDDED INTO EMBANKMENT TO PREVENT PREFERENTIAL FLOW ALONG EDGE OF GABION BASKET FINITIAL STILLING CHECK DAM - 20-40MM FILTRATION CONSTRUCTED FROM ACCESS TRACK STONE PLACED PRIOR 20-40MM CLEAN STONE CORE WITH TO GABIONS 200MM COVER OF 100MM SINGLE SIZE STONE 10000 - DIVERT ROADSIDE DITCH INTO SETTLEMENT POND YY' OVERFLOW DISCHARGE TO COLLECTOR DITCH EXTEND BOUNDARY BERMS TO PREVENT OVERFLOW SWALE TO BE WIDENED AT ENTRY TO POND

ZZ'

DETAIL AI

| POND SIZE W [M] X L [M] X D [M] | | CA | ATCHMENT SIZE (M | 1 ²) | |
|---------------------------------|-----------------|----------------|------------------|------------------|------------------|
| RETURN PERIOD | 10 YRS | STORM DURATION | 500 | 1000 | 2000 |
| 6HR RETENTION I | FOR COARSE SILT | 6 HRS | 1.0 x 3.5 x l m | I.25x 3.75 x I M | 2.0 x 6.25 x l m |
| IIHR RETENTION I | FOR MEDIUM SILT | II HRS | 1.5 x 4.5 x l m | 2.0 x 6.0 x l m | 2.75x 8.25x I M |
| 24HR RETENTION | N FOR FINE SILT | 24 HRS | 2.25x 6.75x I M | 3.0 x 9.0 x l M | 4.0 x I3.0 x I M |


TYPE A - TYPICAL ROAD SIDE SETTLEMENT POND DETAIL SCALE 1:200 (NOTE DIMENSIONS VARY DEPENDING ON CATCHMENT SIZE - SEE ATTACHED TABLE)

EMBANKMENTS TO BE CONSTRUCTED -FROM SUITABLE EXCAVATED MATERIALS. POST CONSTRUCTION PERMENANT WATER LEVEL -PHASE EMBANKMENT MATERIALS TO OUTFLOW CONTROL LEVEL ~ GABION BASKET BE USED TO INFILL POND. TO BE SET 500MM MAIN SETTLEMENT POND PHASING OF INFILL TO BE AGREED BELOW TOP OF GABION FOREBAY TO BE CLEANED WITH SUDS DESIGNER OUT REGULARLY DISCHARGE COLLECTOR DITCH-1000 ▗▗▗▗▗╌╌╌╌╌╬┝╎┼┟┤┼┤┼╎┼┆┼┆┼┆┼╎┼╟┼┼┼┼┼┼ ACCESS TRACK BED SLOPE 1:50MAX. · A · A . · A - INVERT OF 800 STORAGE DEPTH INLET V-DITCH - GEOTEXTILE -100mm single sized stone WRAP PLACED AT ENTRANCE TO SETTLEMENT SILT WILL COLLECT IN THE BASE OF THE DISCHARGE LEVEL POND AND AND WITHIN FOREBAY AREA SETTLEMENT POND. THIS WILL HAVE TO BE CLEANED OUT REGULARLY. SILT BUILD **SCALE 1:100** SCALE 1:100 UP SHOULD BE MONITORED ON SITE.

LI00MM SINGLE SIZED STONE

AND AND WITHIN FOREBAY AREA

PLACED AT ENTRANCE TO SETTLEMENT POND

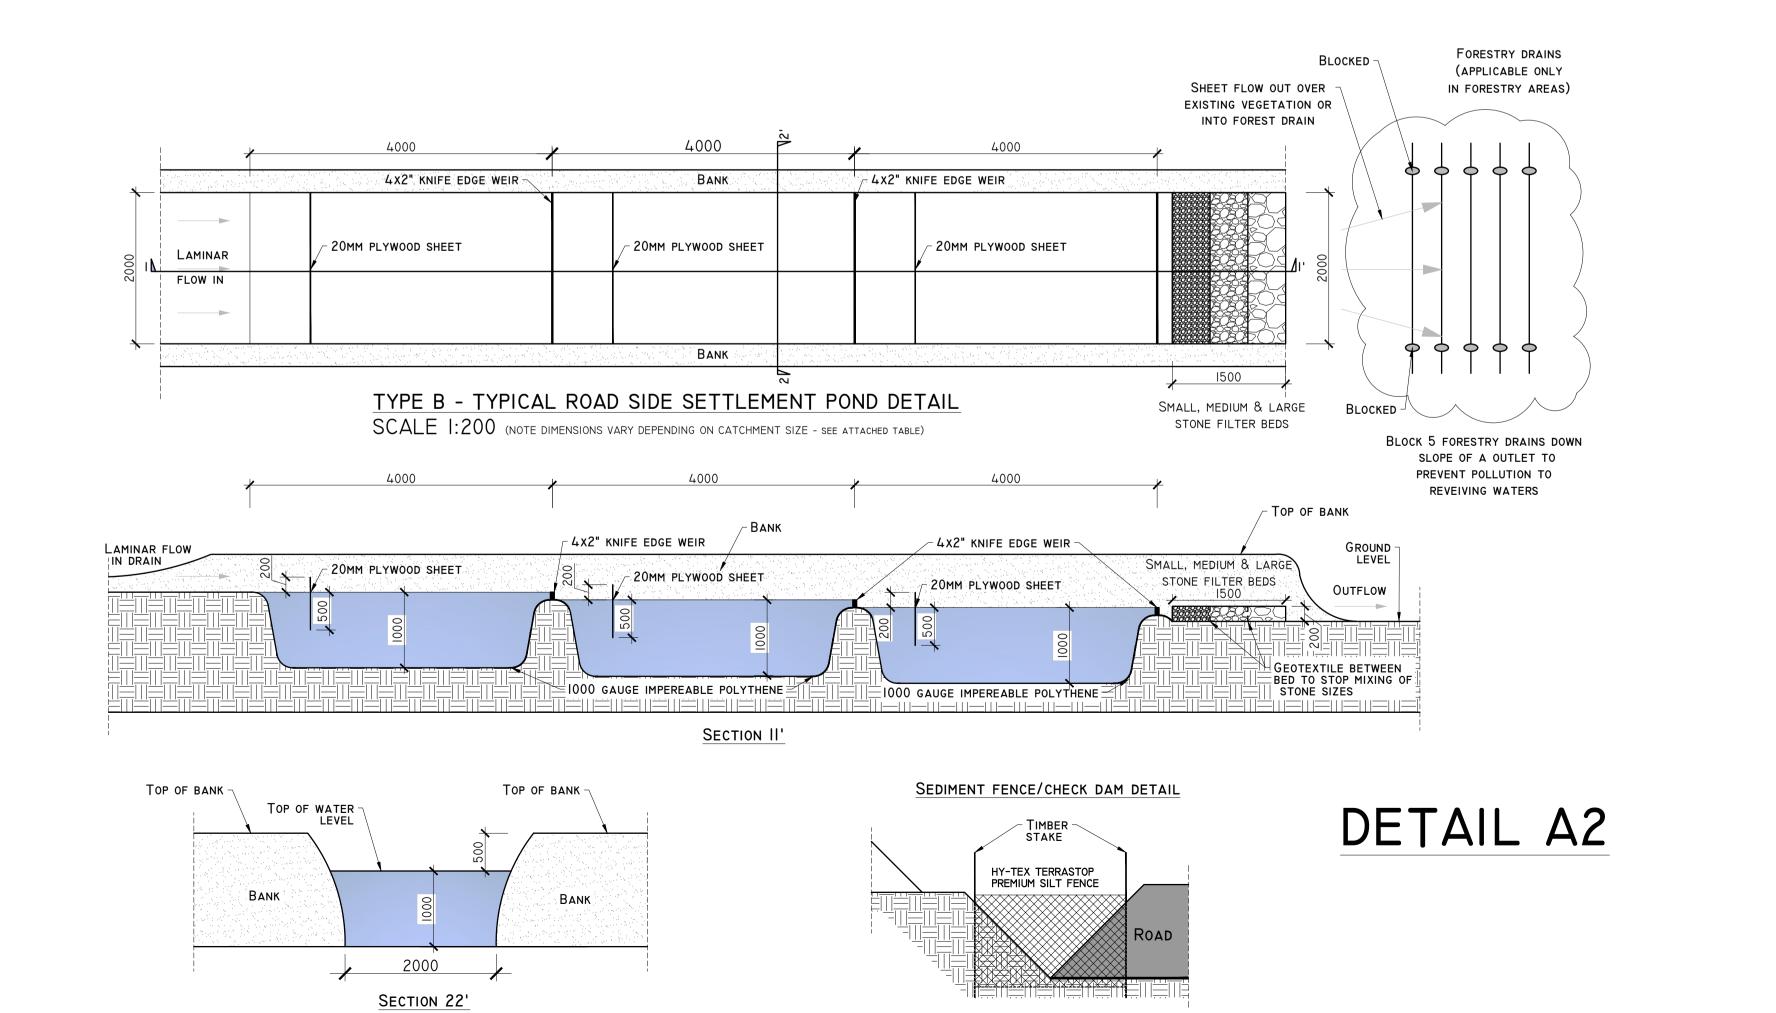

MG MG 09/02/23 Planning Date Description Chkd Signed Revisions

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Client: UMMA MORE LTD


UMMA MORE RENEWABLE ENERGY DEVELOPMENT

DRAINAGE DETAILS I

Figure No: D50I


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DETAIL B

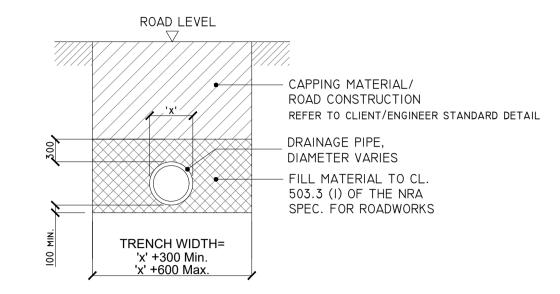


'TYPE B' CULVERT - DRAINAGE CROSSING BENEATH EXCAVATED ROAD


DETAIL C

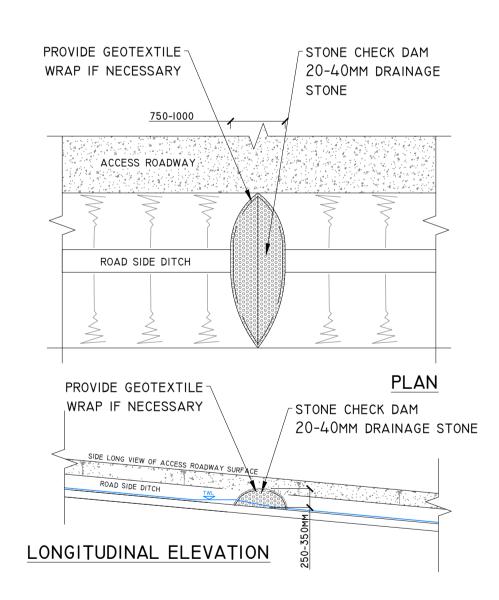


TYPE X - CHECK DAM DETAIL


DETAIL D

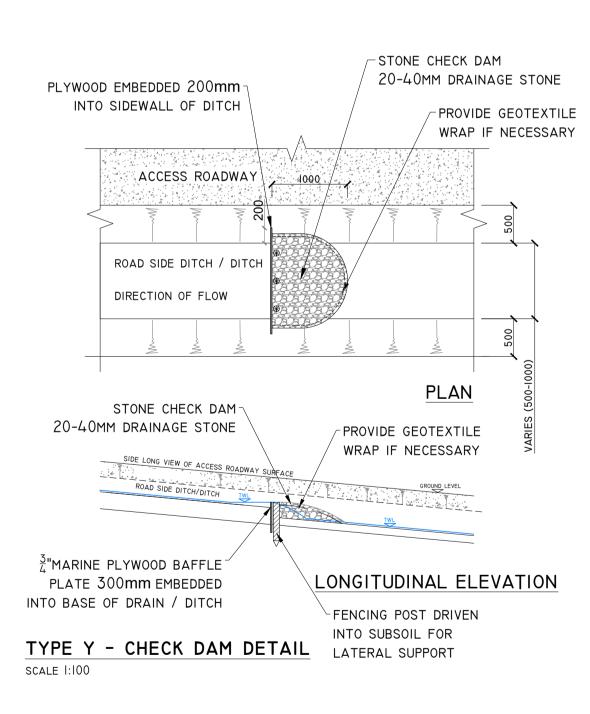

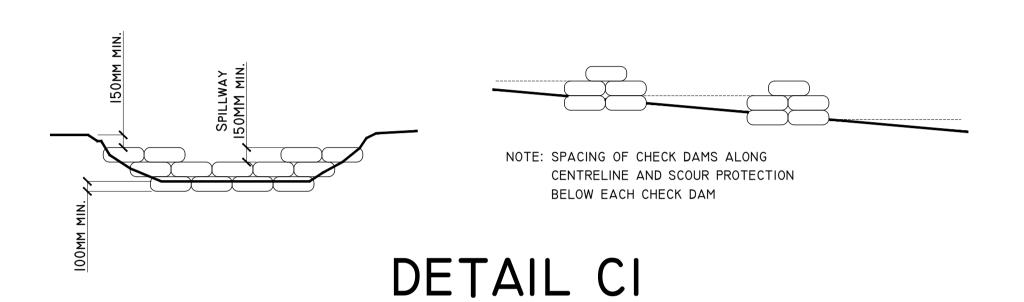

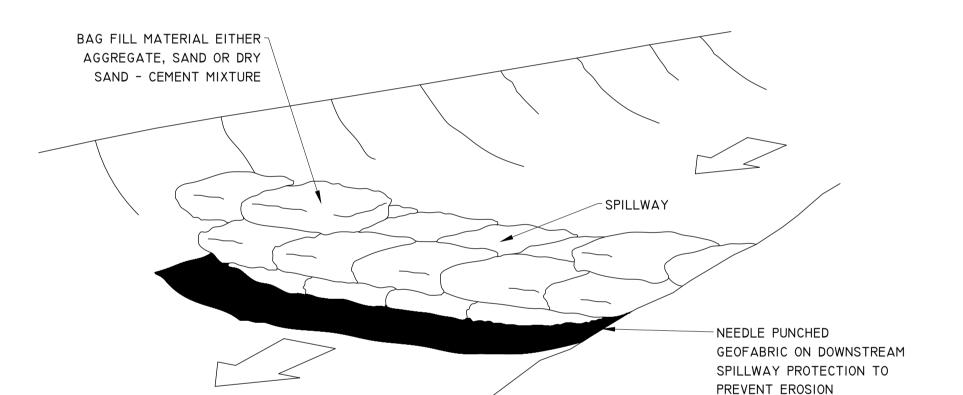

TEMPORARY CHECK DAM / SETTLEMENT POND OVERFLOW SAND FILLED BAG CONSTRUCTION SCHEMATIC - NOT TO SCALE

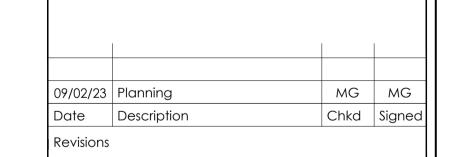

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tel: +353 (0) 58-44244
email: info@hydroenvironmental.ie Ireland web: www.hydroenvironmental.ie

Client:

Figure No:

Date: 09/02/2023

UMMA MORE LTD


UMMA MORE RENEWABLE ENERGY DEVELOPMENT

DRAINAGE DETAILS 2


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D502

DETAIL EI

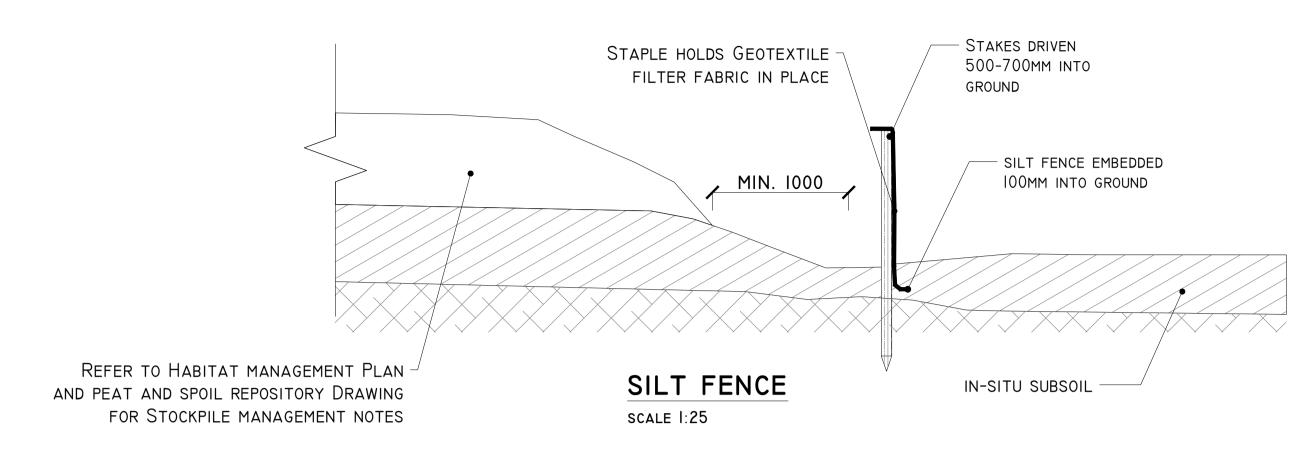


DETAIL E2

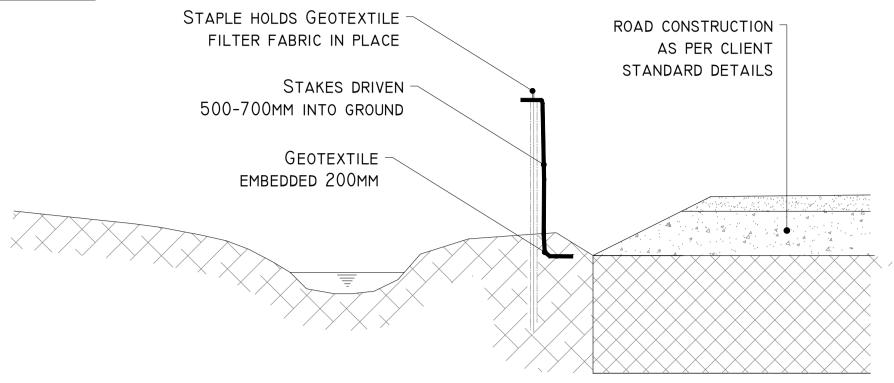


SILT FENCE FOR WATERCOURSE PROTECTION SCALE 1:25

TEMPORARY CONCRETE WASH OUT PIT

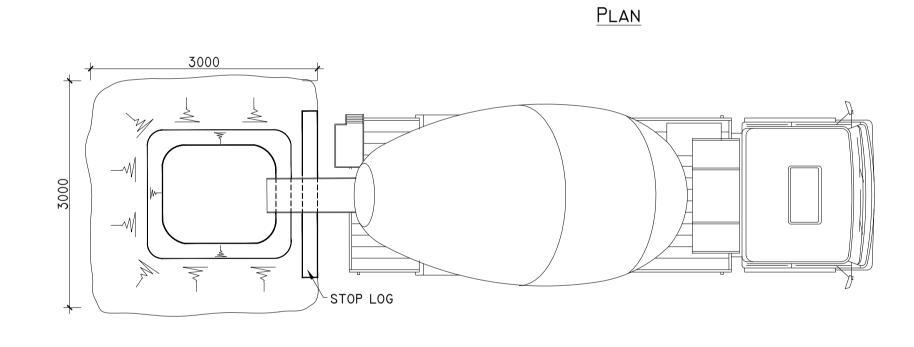


ELEVATION

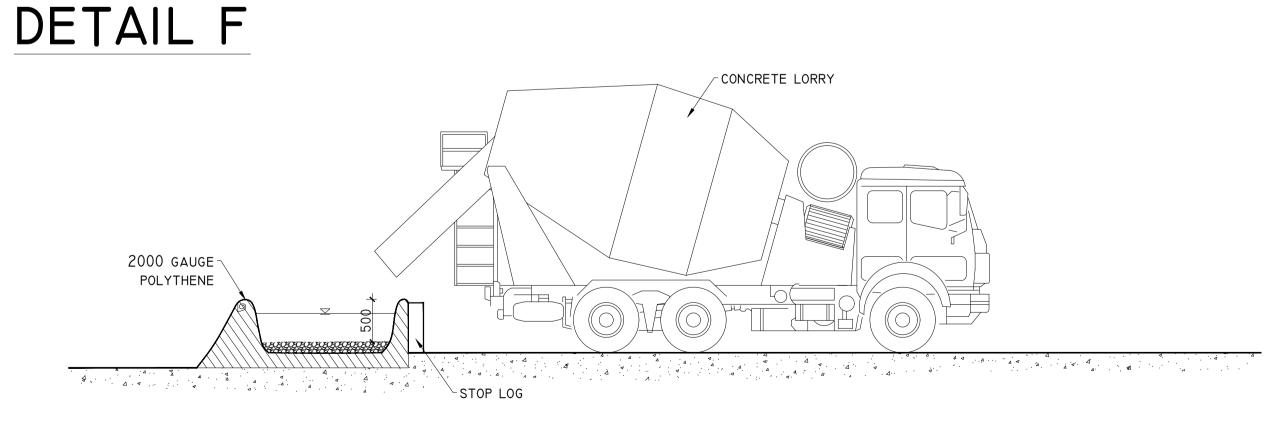

SPREADER LIP STABLE OVERFLOW AREA SECTION AA' SPREADER LIP

DETAIL G2

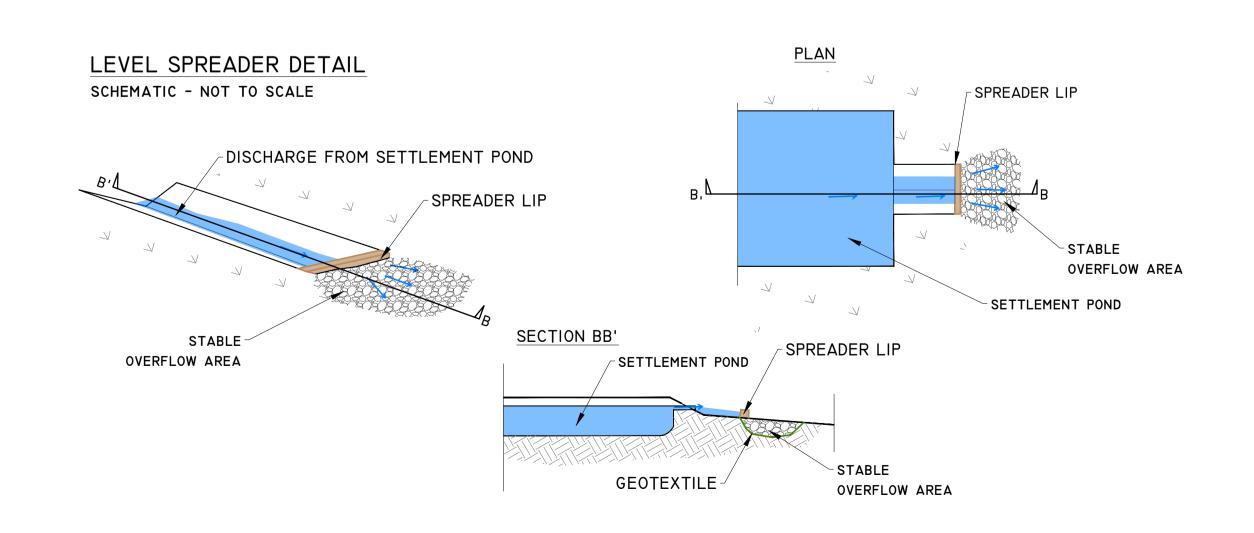

GEOTEXTILE -

STABLE

OVEDELOW ADEA

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|-----------|-------------|------|--------|
| | | | |
| 09/02/23 | Planning | MG | MG |
| Date | Description | Chkd | Signed |
| Revisions | | | |



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DRAINAGE DETAILS 3

| Figure No: | D503 |
|---------------------------------------|----------------------|
| Drawing No: P1553-0-0223-A1-D503-RevA | |
| Sheet Size: A1 | Project No.: P1553-0 |
| Scale: as shown (A1) | Drawn By: MG/GD |

Checked By: M.G.

Date: 09/02/2023